



**US Army Corps  
of Engineers**

Vicksburg District  
4155 Clay Street  
Vicksburg, MS 39183-3435  
[www.mvk.usace.army.mil](http://www.mvk.usace.army.mil)

# Public Notice

APPLICATION NO.:	MVK-2020-290
EVALUATOR:	Ms. Molly Connerton
PHONE NO.:	(601) 937-2373
E-MAIL:	<a href="mailto:Molly.A.Connerton@usace.army.mil">Molly.A.Connerton@usace.army.mil</a>
DATE:	April 30, 2024
EXPIRATION DATE:	May 21, 2024

Interested parties are hereby notified that the U.S. Army Corps of Engineers, Vicksburg District is considering an application for a Department of the Army Permit for the work described herein. Comments should be forwarded to the Vicksburg District, Attention: CEMVK-RD, 4155 East Clay Street, Vicksburg Mississippi 39183-3435, and must reach this office by the cited expiration date.

The Clean Water Act (CWA) Section 401 Water Quality Certification Improvement Rule (Certification Improvement Rule, 40 CFR 121), effective November 27, 2023, requires certification for any license or permit that authorizes an activity that has the potential to result in a discharge. The scope of a CWA Section 401 certification is limited to assuring that a discharge from a Federally licensed or permitted activity will comply with water quality requirements. The applicant is responsible for requesting certification and providing required information to the certifying agency. As of the date of this public notice, the applicant has submitted a certification request to the Louisiana Department of Environmental Quality (certifying authority). In accordance with Certification Rule part 121.6, once the applicant submits a certification request the Corps of Engineers, in conjunction with the certifying agency, will determine a reasonable period of time for them to act upon the certification.

**Law Requiring a Permit:** Section 404 of the Clean Water Act (33 U.S.C. 1344), which applies to discharges of dredged and/or fill material into waters of the United States.

**Name of Applicant:**  
Mayor Friday Ellis  
City of Monroe  
400 Lea Joyner Memorial Expressway  
Monroe, Louisiana 71201

**Name of Agent:**  
Mr. Matt Mixon  
Wetlands Unlimited, LLC  
Post Office Box 1892  
West Monroe, Louisiana 71294

**Location of Work:** Section 32, Township 18 North, Range 4 East, Ouachita Parish, Louisiana (Latitude, 32.506623 Longitude -92.094124, (USGS 8-digit HUC 08050001).

**Description of Work:** (See enclosed maps and drawings.)

The following descriptions of the proposed project and associated impacts are based upon information provided by the applicant.

The applicant is applying for a Department of the Army permit to conduct regulated activities in aquatic resource sites for the purpose of constructing a new stormwater retention area referred to as the Youngs Bayou Retention area in the City of Monroe, Louisiana.

The proposed project will serve as a method of flood prevention for the communities in the area that have suffered damages from floodwater intrusion in recent years. Youngs Bayou currently does not possess the hydraulic capacity to clear the water volumes observed during significant precipitation runoff, such as in the recent flood events, resulting in backups and flooding from the waterway. This project will provide significant additional storage area for potential flood waters during these high-water events to allow the existing downstream drainage systems sufficient time to clear accumulated flows.

The project's proposed construction would mainly occur in undeveloped areas within Monroe's city limits, including a former city-owned landfill and dump area. The project will convert approximately 58 acres of land to an interconnected system of low-elevation retention areas (henceforth referred to as the "retention area"). Most of the property consists of bottomland hardwood overstory cover, except for a cleared and actively maintained city sewer primary right of way that dissects the property from north to south near the center of the project footprint and upland buffer areas adjacent to two channelized drainage systems (Youngs Bayou and Oliver Road Canal) within the project footprint. The majority of the undeveloped hardwood vegetation will be cleared as part of the construction process. Upon completion of the construction process, the project area will be allowed to naturally revert back to wetland conditions. Youngs Bayou and Oliver Road Canal will also be altered as part of the construction process.

The following is a breakdown of the identified aquatic resources found within the project site:

- Palustrine Emergent (PEM) Wetlands - 1.01 acres
- Palustrine Forested (PFO) Wetlands - 66.80 acres
- Perennial Streams- Youngs Bayou (2,795 linear feet) & Oliver Canal (3,103 linear feet)

As a result of project activities for the construction of the proposed retention area (these activities include clearing of trees, excavation, filling and eventual flooding of the retention area), total unavoidable impacts to waters of the U.S. (WOUS) will

include 0.19 acres of permanent impacts to PEM wetlands and 48.91 acres of permanent impacts to PFO wetlands. Initial site preparations will consist of clearing and grubbing of vegetative cover, including overstory trees. Approximately 840,000 cubic yards of material will then need to be excavated to construct the floodwater retention area. Excavated material will be used in the formation of the retention area, where possible and the remaining material will be spread in the upland area to the east of the retention area.

A city sewer right-of-way is positioned in the approximate center of the proposed retention area, extending from the northern property boundary near South 23rd Street, south to the KCS railway right of way. The sewer right-of-way will dissect the largest section of the retention area, forming an approximately 20.15-acre retention area to the west and a 29.43-acre retention area to the east. The two retention areas will be connected by a 100-ft wide connection channel located at approximate latitude 32.5070529°N and approximate longitude 92.0942664°W, where sewer main infrastructure upgrades and relocation will be required. Work within the retention pond connection area will include the removal of an abandoned sewer gravity main, the removal and replacement of an existing sewer gravity main, the installation of sewer support framing, and the installation of 55 lb. riprap (2" thick/10' wide) on both sides of the pipe.

Youngs Bayou, 2,795 linear feet, and Oliver Road Canal, 3,103 linear feet, will also be subjected to alterations as part of the construction process for the retention pond as described here: throughout the project footprint, a portion of the eastern bank of Youngs Bayou will be removed, allowing water to enter the retention areas during high water events. In addition to the reduction of the east bank of Youngs Bayou, two additional similar bank reductions are also proposed, an approximately 110 linear feet section of the west bank of Youngs Bayou near the southern extent of the project footprint, and an approximately 170 linear feet section of the west bank of the Oliver Road Canal near the northeastern corner of the project boundary. The proposed bank reductions are to allow potential floodwaters to enter the retention area during times of elevated flow, thus providing relief for Youngs Bayou and the Oliver Road Canal until accumulated waters can clear downstream. Flow within Youngs Bayou and the Oliver Road Canal will not be diverted into the retention areas during normal flow cycles. Flows will only discharge into the retention areas during times of elevated flow volumes.

The project had been designed to minimize wetland impacts. Best management practices such as silt-fences will be installed to prevent impacts to aquatic resources that are being avoided by site design. Negative impacts to the areas within the proposed 58-acre retention area will be temporary in nature due to the fact that post-construction, the area will be allowed to evolve naturally and return to historic wetland conditions in the pre-project wetland areas while also seeing an expansion of wetland acreage with the conversion of pre-project upland areas

to wetlands. For unavoidable impacts, the applicant proposes to purchase the required compensatory mitigation credits from a USACE Vicksburg District approved mitigation bank in the same 8-digit HUC.

The majority of the proposed area for the Youngs Bayou Retention area is currently forested. Primary hydrology indicators observed on site include surface water, high water table, saturation, drainage patterns, FAC-Neutral Test, and oxidized rhizospheres along living roots. The dominant wetland vegetation within the project area consists of Water oak (*Quercus Nigra*), American sycamore (*Plantanus occidentalis*), Chinese tallow (*Triadica sebifera*), Sweetgum (*Liquidambar styraciflua*), Boxelder (*Acer Negundo*), Soft Rush (*Juncus effusus*), Devil's Daring Needles (*Clematis virginiana*), Fox Sedge (*Carex vulpinoidea*), and Pricklefruit buttercup (*Ranunculus muricatus*). Soil within the project area consists of Loring silt loam and Oaklimeter silt loam.

Upon reviewing this notice, you should write to this office to provide your opinion of the impacts this work will have on the natural and human environment and address any mitigation you believe is necessary to offset these impacts. Other comments are welcome, but the above information will further our review of the applicant's plan as proposed. Comments of a general nature are not as helpful as those specific to the impacts of the subject project.

**State Water Quality Permit:** The State Pollution Control Agency must certify that the described work will comply with the State's water quality standards and effluent limitations before a Corps permit is issued.

**Cultural Resources:** Currently this office is coordinating with the lead Federal agency (HUD), the State Historic Preservation Officer, Federally-recognized Tribes, and other interested parties regarding potential effects to historic properties that could result from the proposed activity.

Copies of this Public Notice have been sent to the State Historic Preservation Officer, Federally Recognized Tribes, and other interested parties for comment on potential effects to historic properties that could result from the proposed activity.

**Endangered Species:** Threatened and Endangered Species for this area include the Red-cockaded woodpecker (Endangered) and the Northern long-eared bat (Endangered). Utilizing the Information for Planning and Consultation (IPAC) tool for Endangered Species in Louisiana (as per Memorandum of Agreement, signed on January 14, 2020, between the U.S. Army Corps of Engineers, Vicksburg District and the U.S. Fish and Wildlife Service, Louisiana Ecological Services Office), the Corps has determined that the proposed activities are not likely to adversely affect the Northern Long-eared Bat and would have no effect on the Red Cockaded Woodpecker.

**Floodplain:** In accordance with 44 CFR Part 60 (Floodplain Management and Use), participating communities are required to review all proposed development to determine if a floodplain development permit is required. Floodplain



administrators should review the proposed development described in this public notice and apprise this office of any flood plain development permit requirements. The entire project site is located above the 100-year floodplain.


**Evaluation Factors:** The decision whether or not to issue a permit will be based upon an evaluation of the probable impact of the proposed activity on the public interest. That decision will reflect the national concern for both protection and utilization of important resources. The benefits which may be expected to accrue from the proposal must be balanced against its expected adverse effects. All factors which may be relevant to the proposal will be considered; among these are conservation, economics, aesthetics, general environmental concerns, historic values, fish and wildlife values, flood damage prevention, land use classification, navigation, recreation, water supply, water quality, energy needs, safety, food requirements and, in general, the needs and welfare of the people. Evaluation of the proposed activity will include application of the guidelines published by the Environmental Protection Agency under authority of Section 404(b) of the Clean Water Act.

**Public Involvement:** The purpose of this notice is to solicit comments from the public; Federal, State, and local agencies and officials; Indian Tribes; and other interested parties. These comments will be used to evaluate the impacts of this project. All comments will be considered and used to help determine whether to issue the permit, deny the permit, or issue the permit with conditions, and to help us determine the amount and type of mitigation necessary. This information will be used in our Environmental Assessment or Impact Statement. Comments are also used to determine the need for a public hearing.


**Opportunity for a Public Hearing:** Any person may make a written request for a public hearing to consider this permit application. This request must be submitted by the public notice expiration date and must clearly state why a hearing is necessary. Failure of any agency or individual to comment on this notice will be interpreted to mean that there is no objection to the proposed work. Please bring this announcement to the attention of anyone you know who might be interested in this matter.

**Notification of Final Permit Actions:** Each month, the final permit actions from the preceding month are published on the Vicksburg District Regulatory web page. To access this information, you may follow the link from the Regulatory web page, <http://www.mvk.usace.army.mil/Missions/Regulatory.aspx>.

Andy Sanderson  
Chief, Louisiana Branch  
Regulatory Division

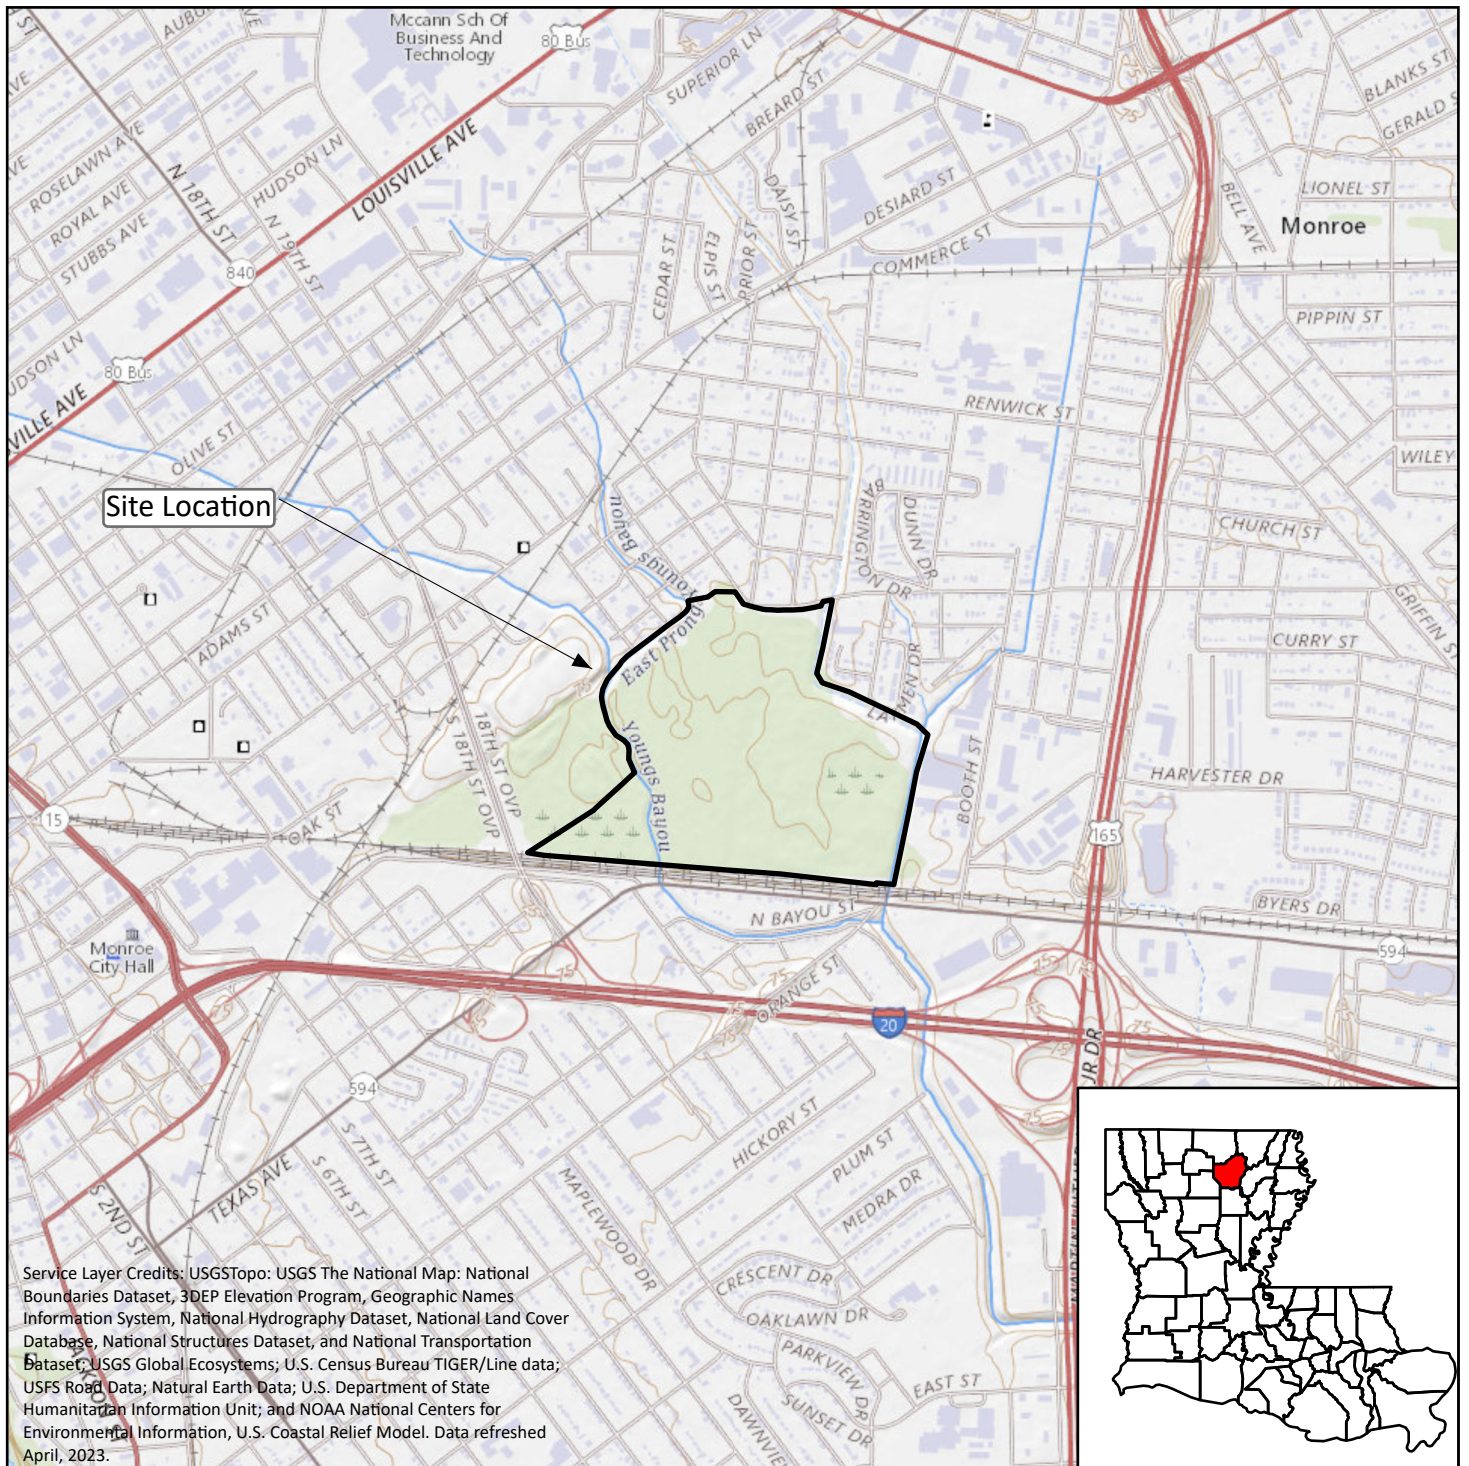

SCALE: 1:24,000

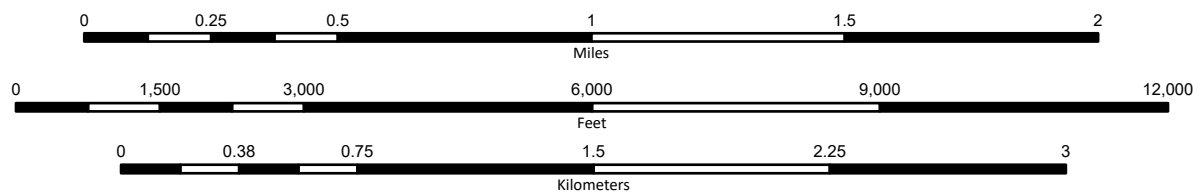

CHECK BY	MM
DRAWN BY	TS
DATE	11/07/23
SCALE	AS SHOWN
CAD NO.	N/A
PRJ NO.	2019.017

### Legend

Project Boundary

Site Location Map  
Youngs Bayou Retention Area Project  
USACE Project No. MVK-2020-290  
City of Monroe  
Monroe, Louisiana



FIGURE

1





CHECKED BY: MM

DRAWN BY: TS

DATE: 11/7/2023

SCALE: AS SHOWN

CAD NO: N/A

PROJ NO: 2019.017

Legend

Project Boundary

Bank Removal Areas

Perennial Stream

Proposed Area to Spread Excavation

Proposed Retention Pond

Fill Impact Areas

Flood Impact Areas

00.040.070.150.220.3

Miles

Site Detail Map

Youngs Bayou Retention Area Project

USACE Project No. MVK-2020-290

City of Monroe

Monroe, Louisiana

FIGURE

2





## Legend

- Project Boundary
- PEM Wetland
- PFO Wetland
- Perennial RPW

\*There are wetlands and other waters of the U.S. within the proposed area.  
ENCLOSURE 1






INDEX TO SHEETS

SHEET NO.	DESCRIPTION
1	TITLE SHEET
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3	PROJECT LAYOUT
4-5	TYPICAL SECTIONS
6-11	PLAN PROFILE
12	SEWER REPLACEMENT DETAILS
13	WATER RELOCATION DETAILS
14-17	SOIL BORINGS

YOUNGS BAYOU RETENTION  
OUACHITA PARISH  
DATE: DECEMBER, 2022



PROJECT LOCATION

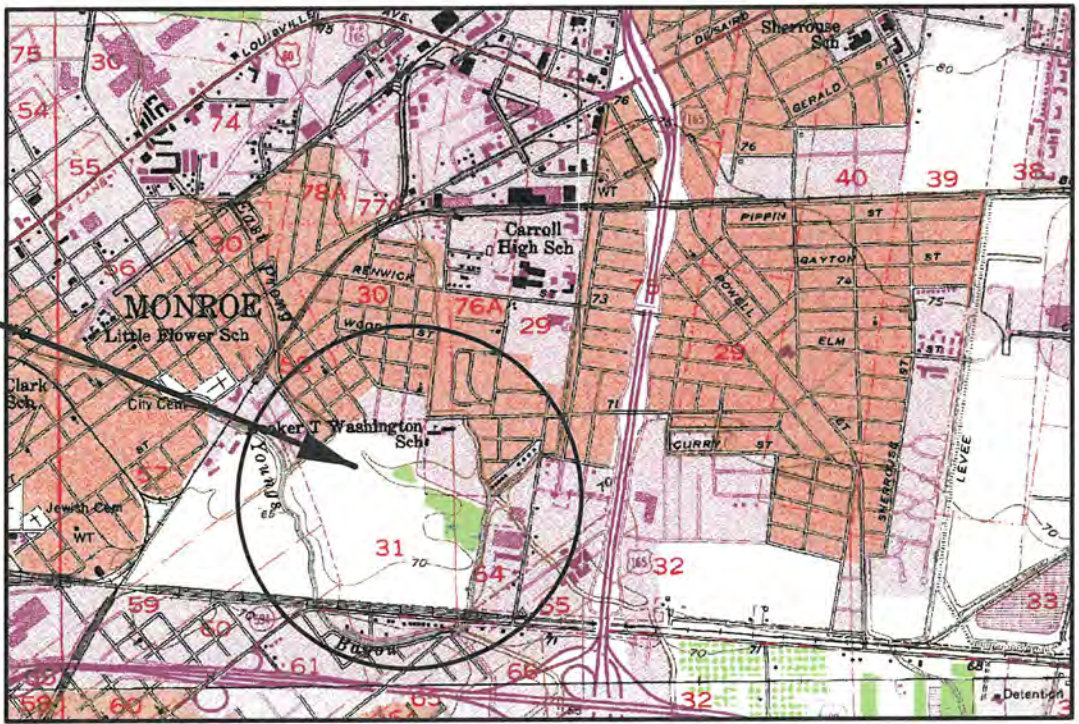

VICINITY MAP

CITY OF MONROE &

MAYOR, HONORABLE FRIDAY ELLIS

CITY COUNCIL:

- |             |                      |
|-------------|----------------------|
| DISTRICT 1, | DOUG HARVEY          |
| DISTRICT 2, | GRETCHEN EZERNACK    |
| DISTRICT 3, | JUANITA G. WOODSWOOD |
| DISTRICT 4, | CARDAY MARSHALL, SR. |
| DISTRICT 5, | KEMA DAWSON          |

APPROVED \_\_\_\_\_ DATE \_\_\_\_\_  
RANDY A. DENMON, P.E.  
VOLKERT, INC.

STANDARD PLANS

EC-01, EROSION CONTROL

TYPE OF CONSTRUCTION:  
EARTHWORK, DRAINAGE AND LEVEES

NOTE:  
THE 2016 EDITION OF THE LOUISIANA DOTD  
STANDARD SPECIFICATIONS FOR ROADS AND  
BRIDGES, AS AMENDED BY THE PROJECT  
SPECIFICATIONS, SHALL GOVERN ON THIS PROJECT.

VOLKERT, INC  
PREPARED BY


ENGINEERS AND SURVEYORS  
MONROE, LOUISIANA

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- ☒ PRELIMINARY - FOR REVIEW ONLY
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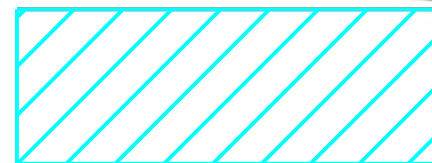


TOTAL PROJECT AREA: 119 ACRES

DETENTION AREA: 58 ACRES

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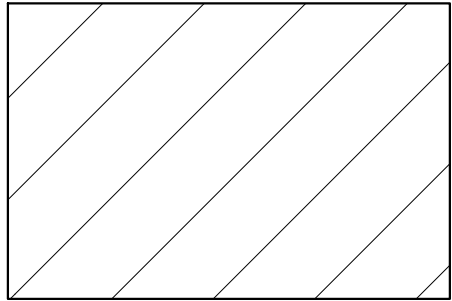
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YOUNGS BAYOU RETENTION		
VOLKERT		

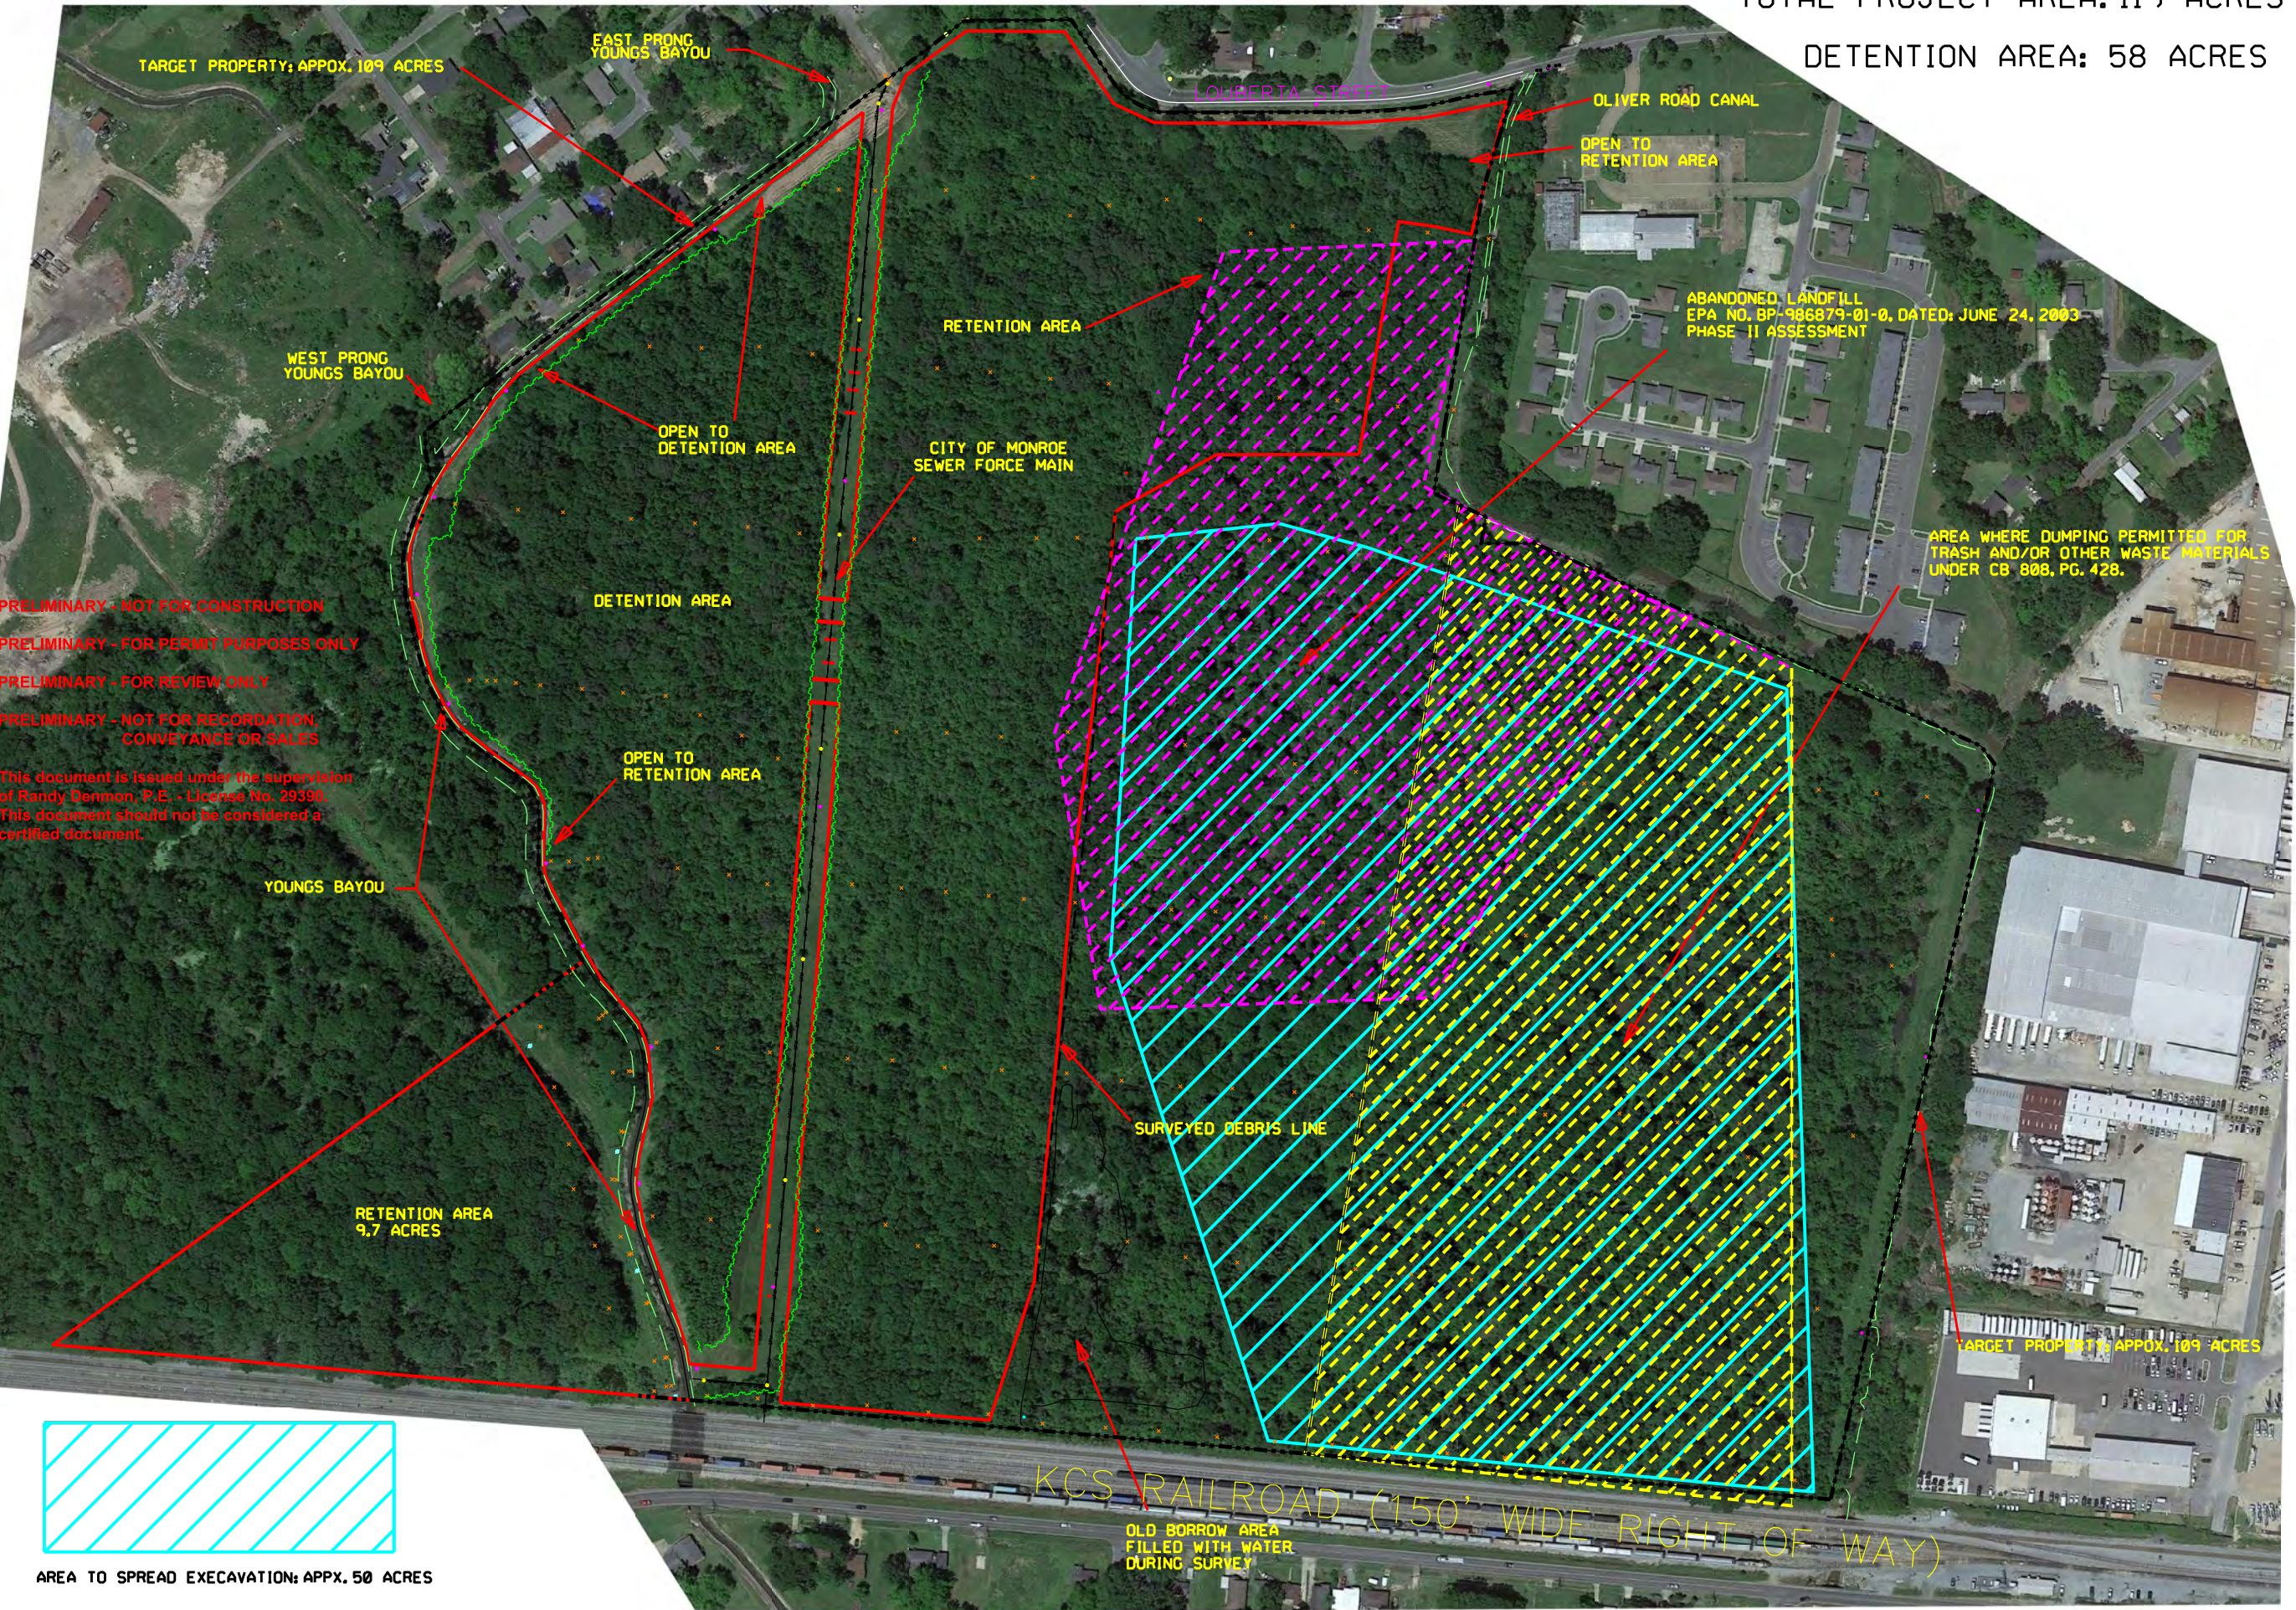


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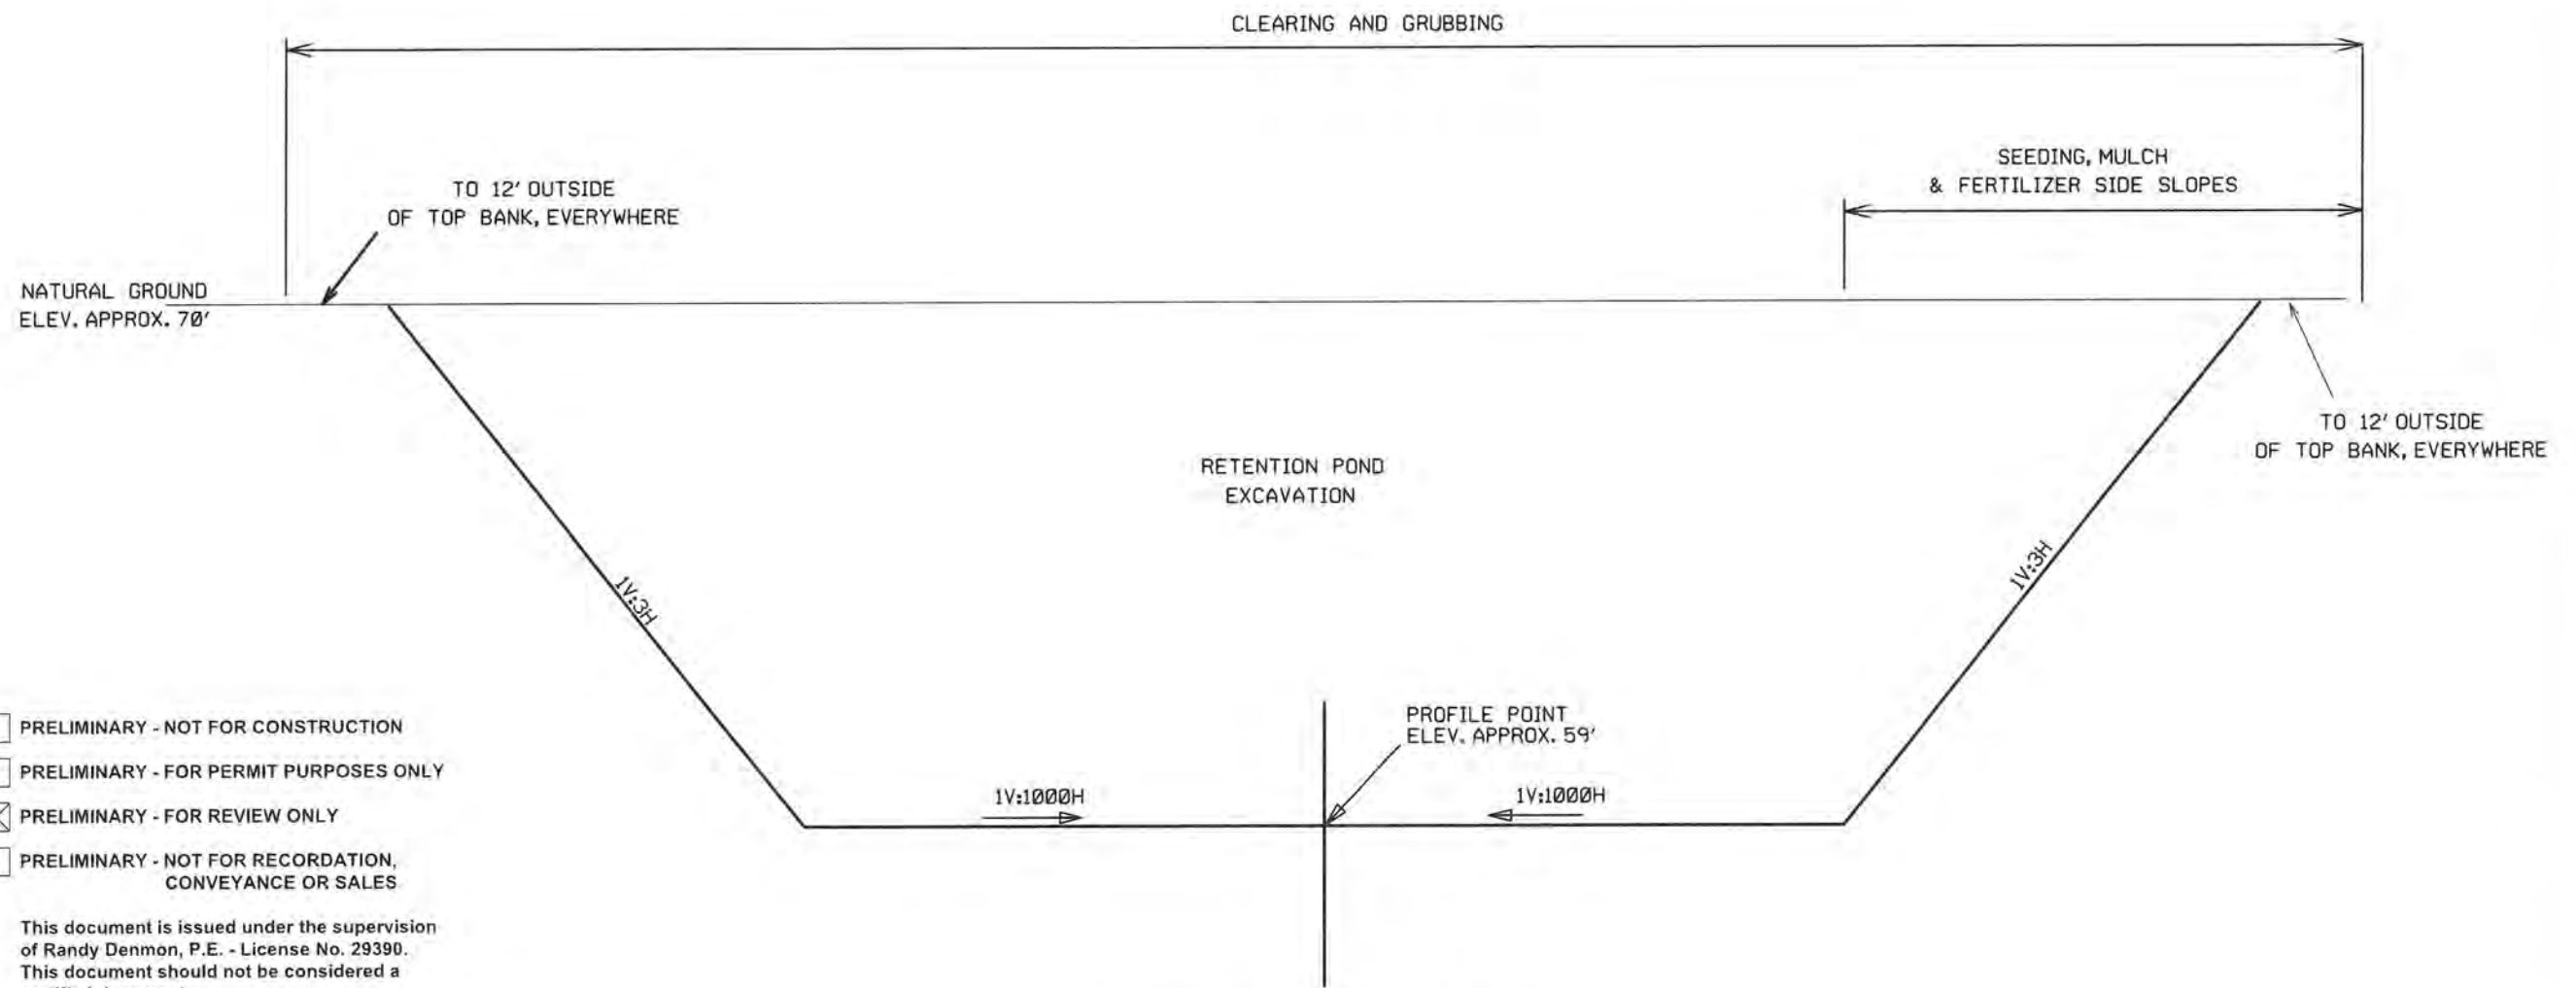
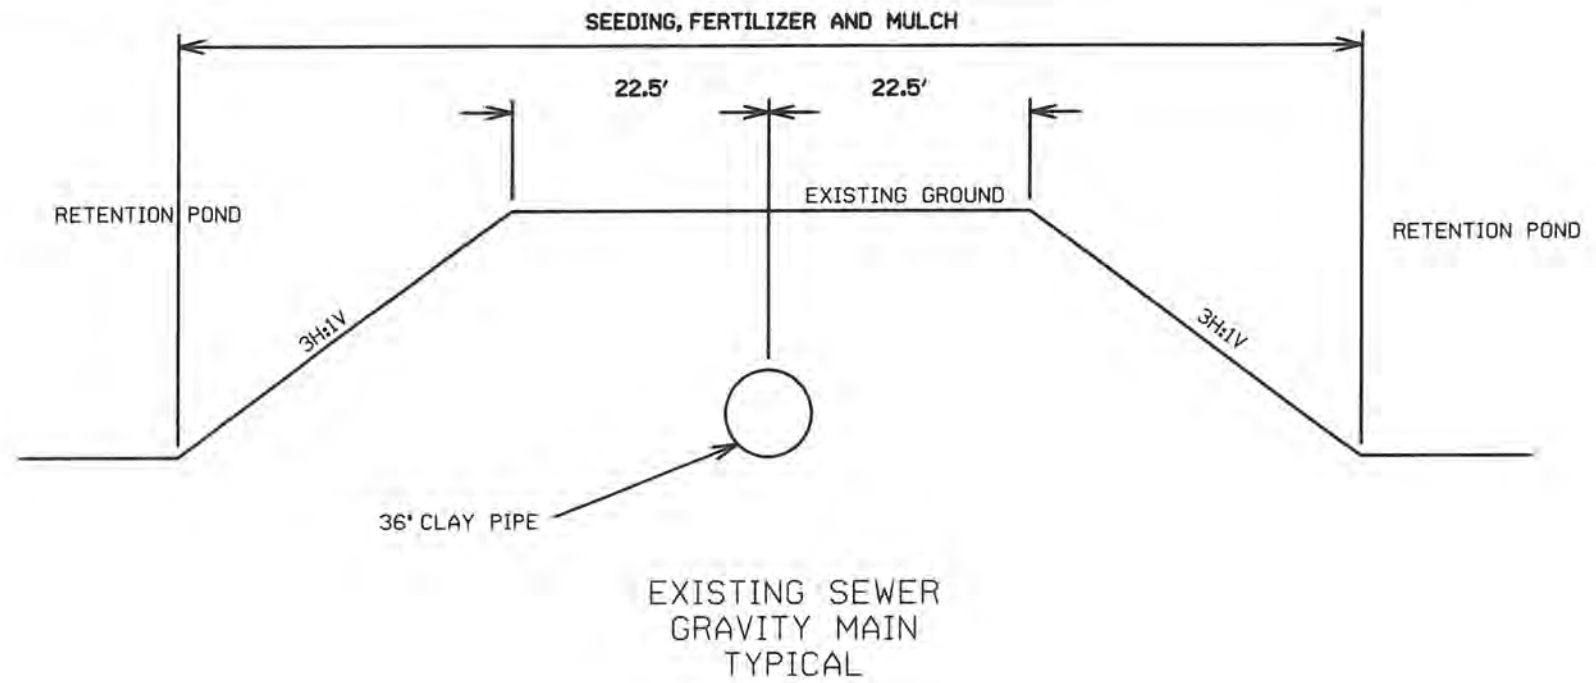
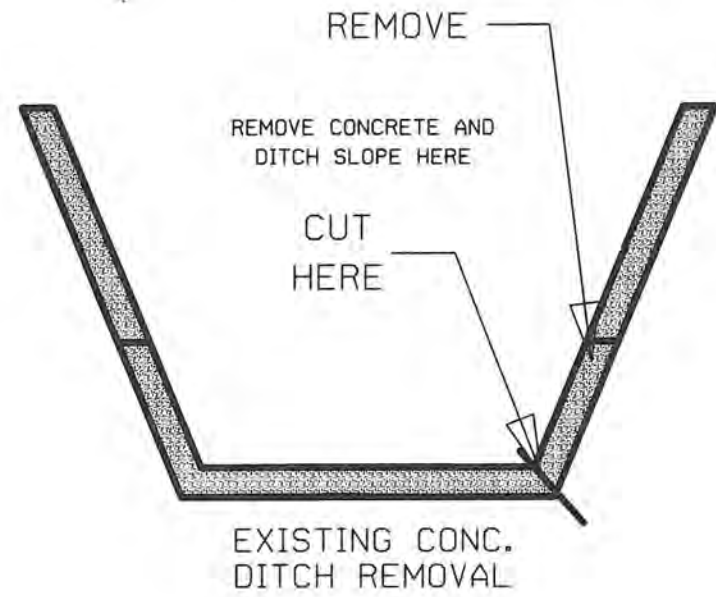


AREA TO SPREAD EXCAVATION: APPX. 50 ACRES  
15' HEIGHT MAXIMUM, WITH 3H:1 SIDE SLOPES



DETENTION AREA: 58 ACRES
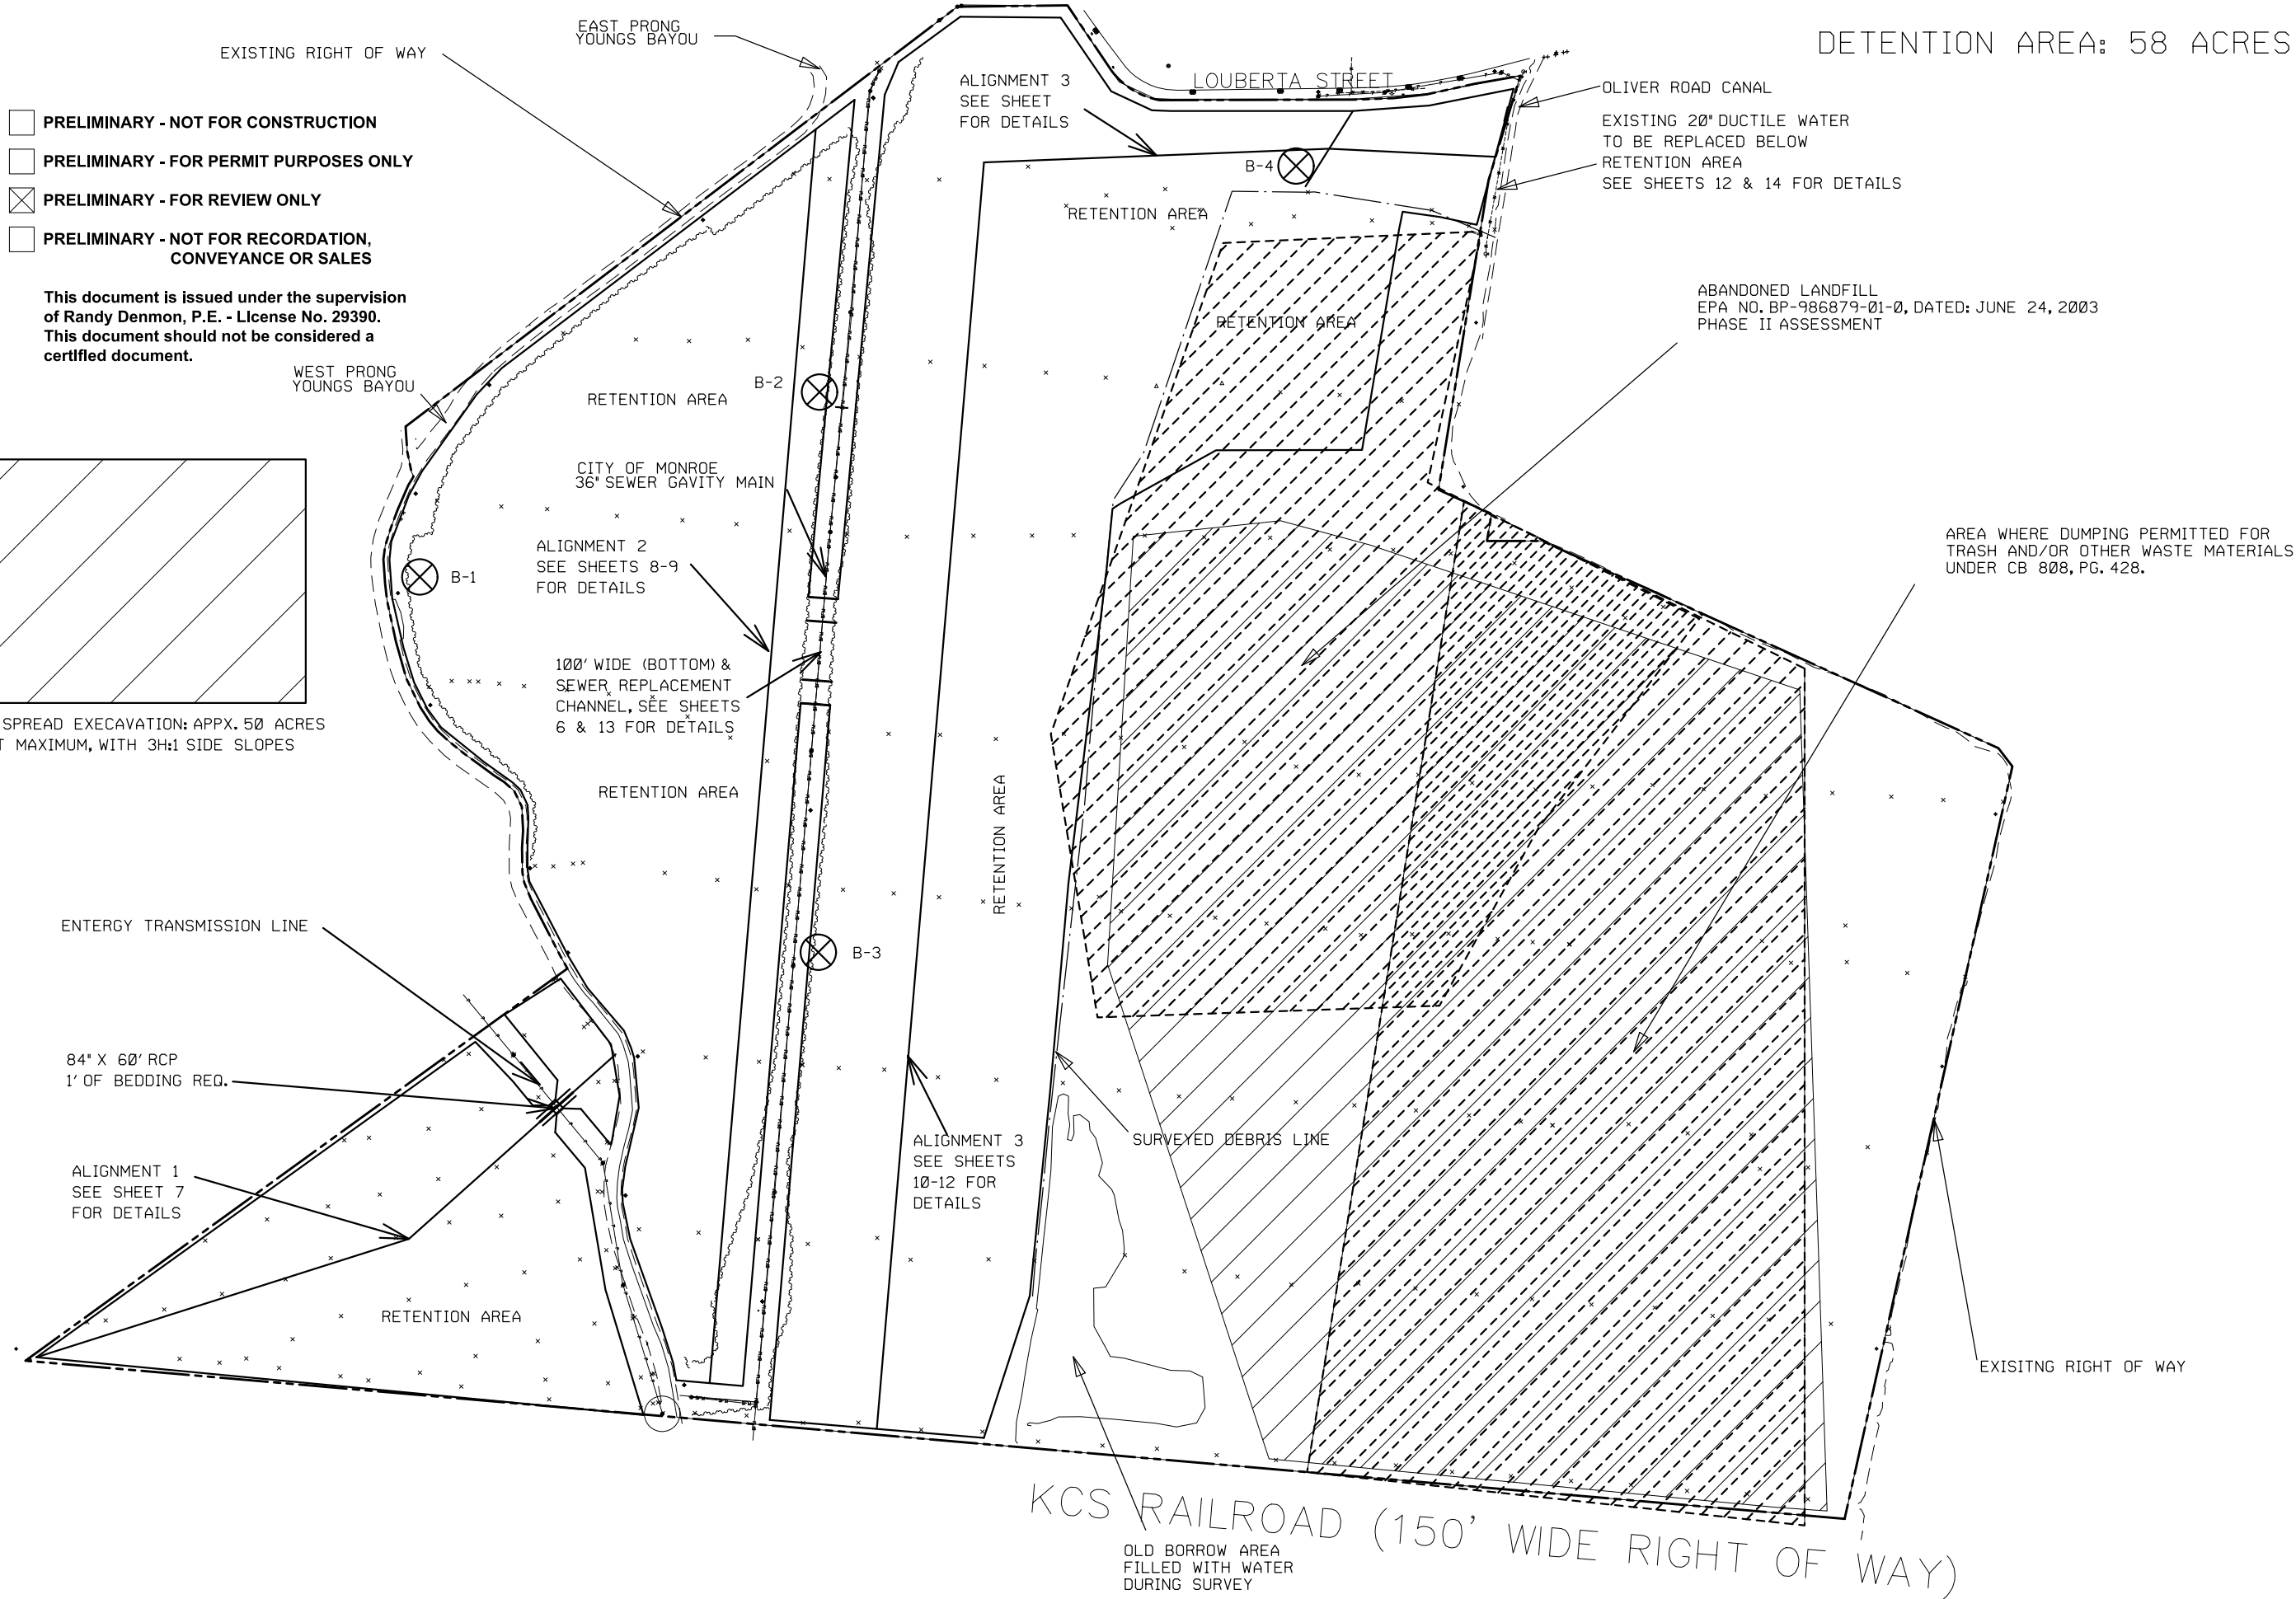
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PROJECT LAYOUT		YOUNGS BAYOU RETENTION
VOLKERT		
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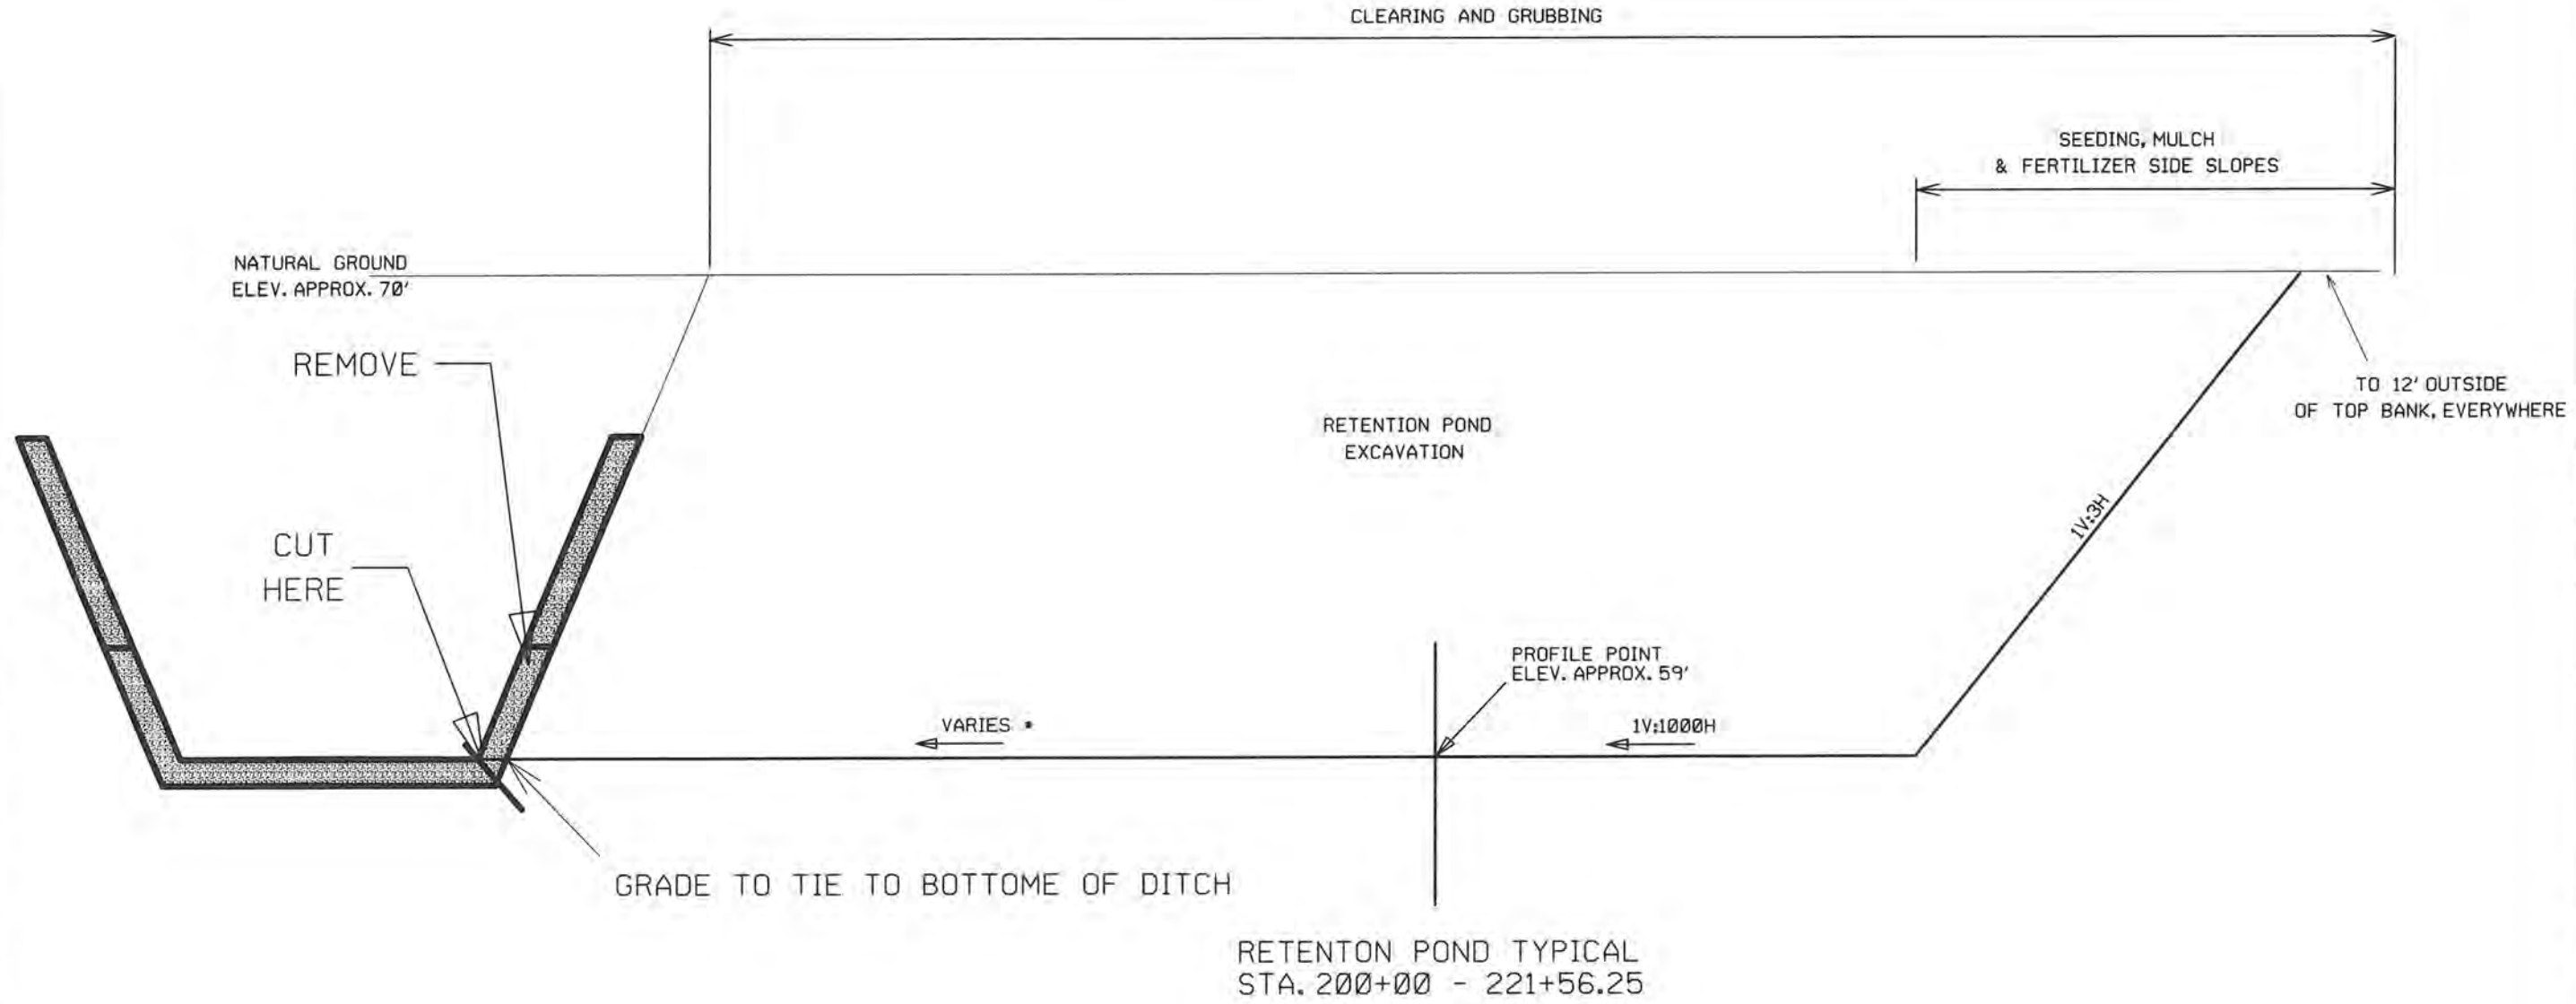
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RETENTION POND TYPICAL  
STA. 100+00-111+41.58 & 300+00 - 330+18.07


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


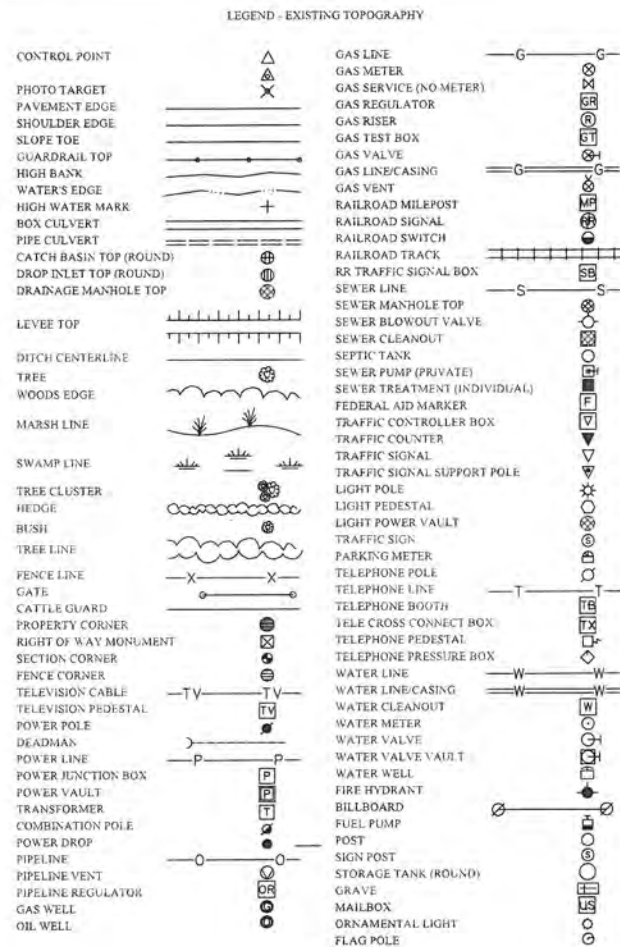


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VOLKERT	TYPICAL SECTIONS		NO.	DATE	REVISION OR CHANGE ORDER DESCRIPTION	BY	DESIGNED	R.A.D.	PARISH	OUACHITA	SHEET NUMBER			
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YOUNGS BAYOU RETENTION														





NOTES:

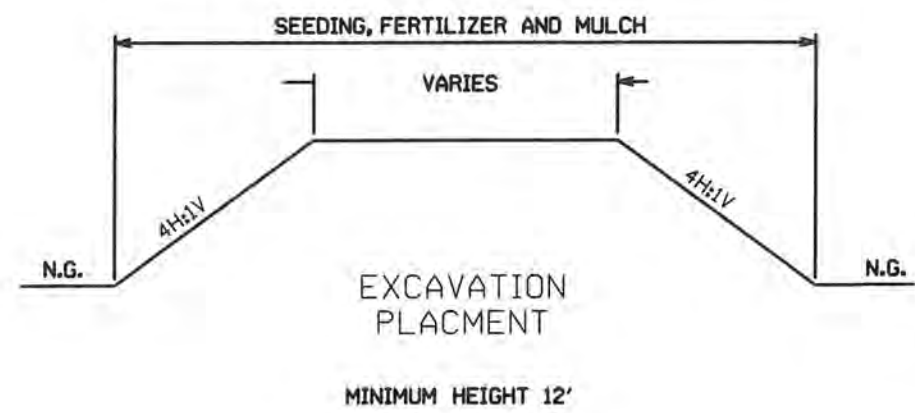CONTRACTOR WILL BE REQUIRED TO MAINTAIN EROSION CONTROL IN ACCORDANCE WITH EC-01, NO DIRECT PAYMENT.

ALL DISTURBED AREAS TO BE SEEDED, MULCHED AND FERTILIZED.

CONTRACTOR REQUIRED TO DO ALL BYPASS PUMPING REQUIRED FOR SEWER REPLACEMENT.

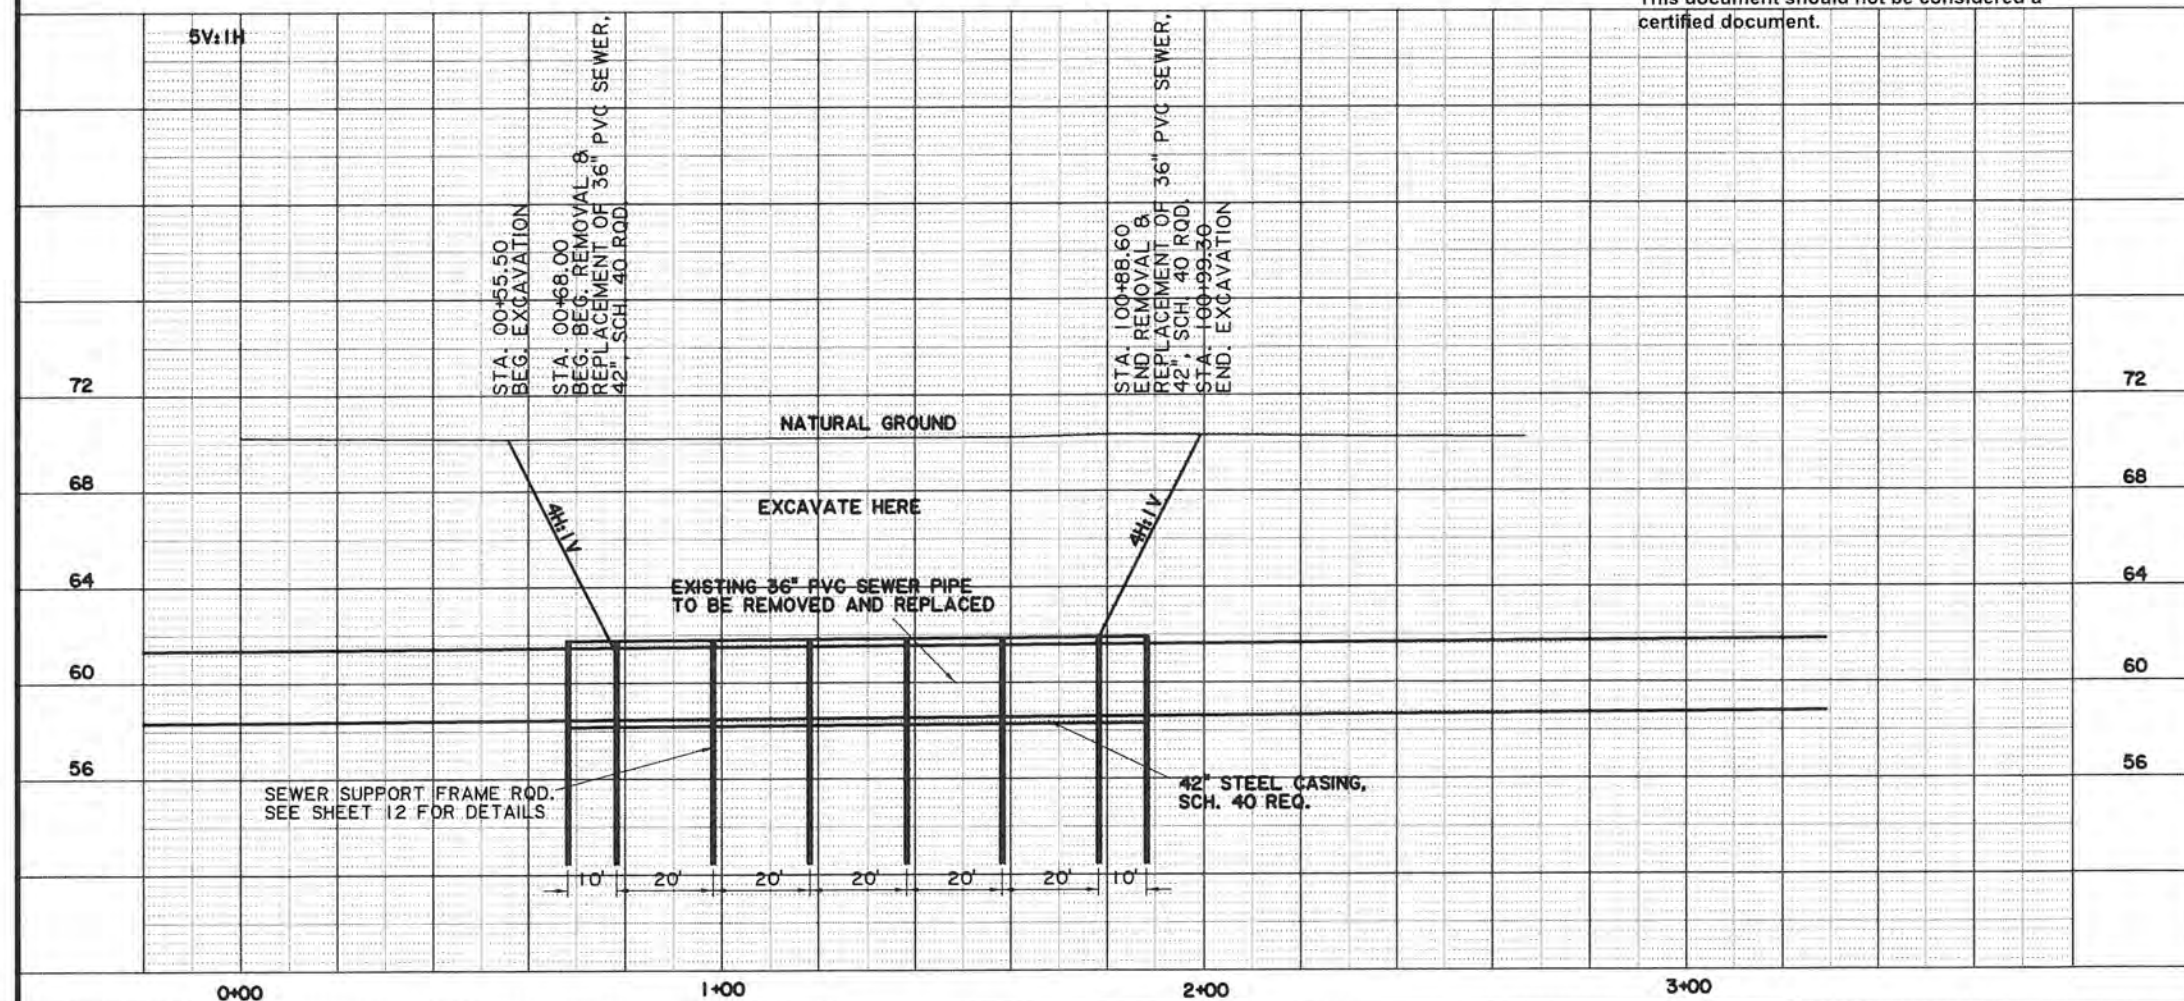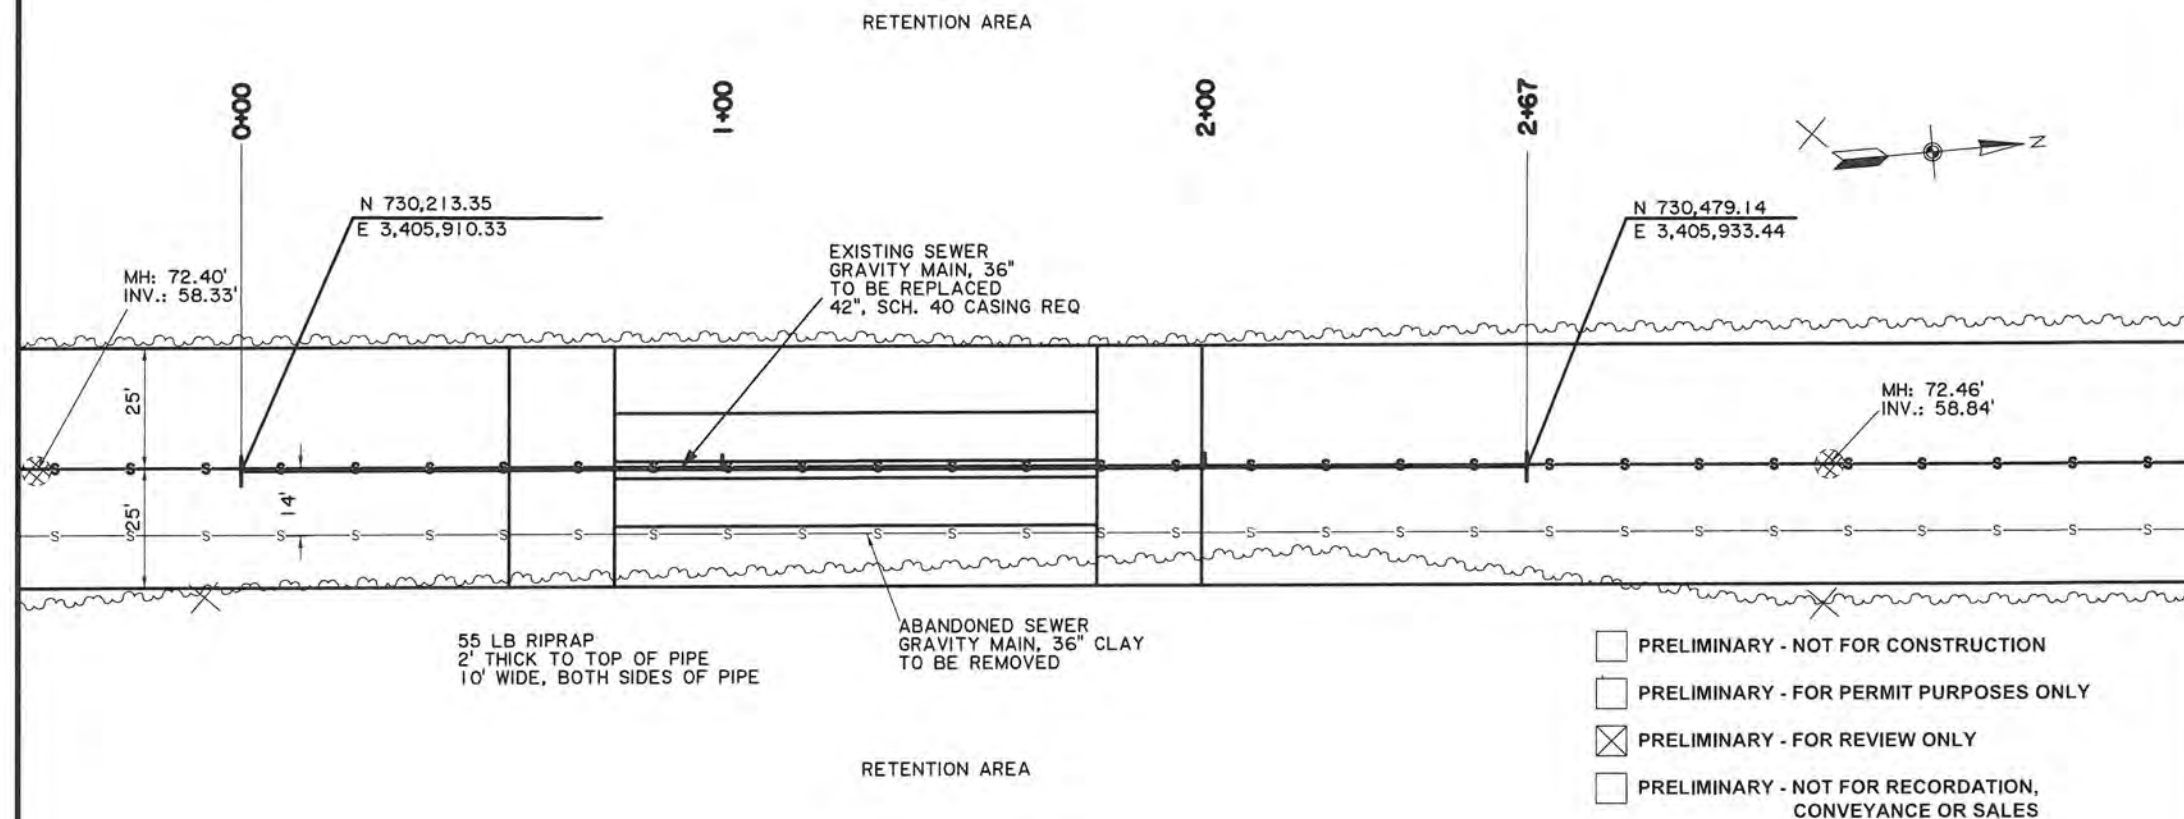


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PLAN AND PROFILE SHEET SEWER REPLACEMENT	
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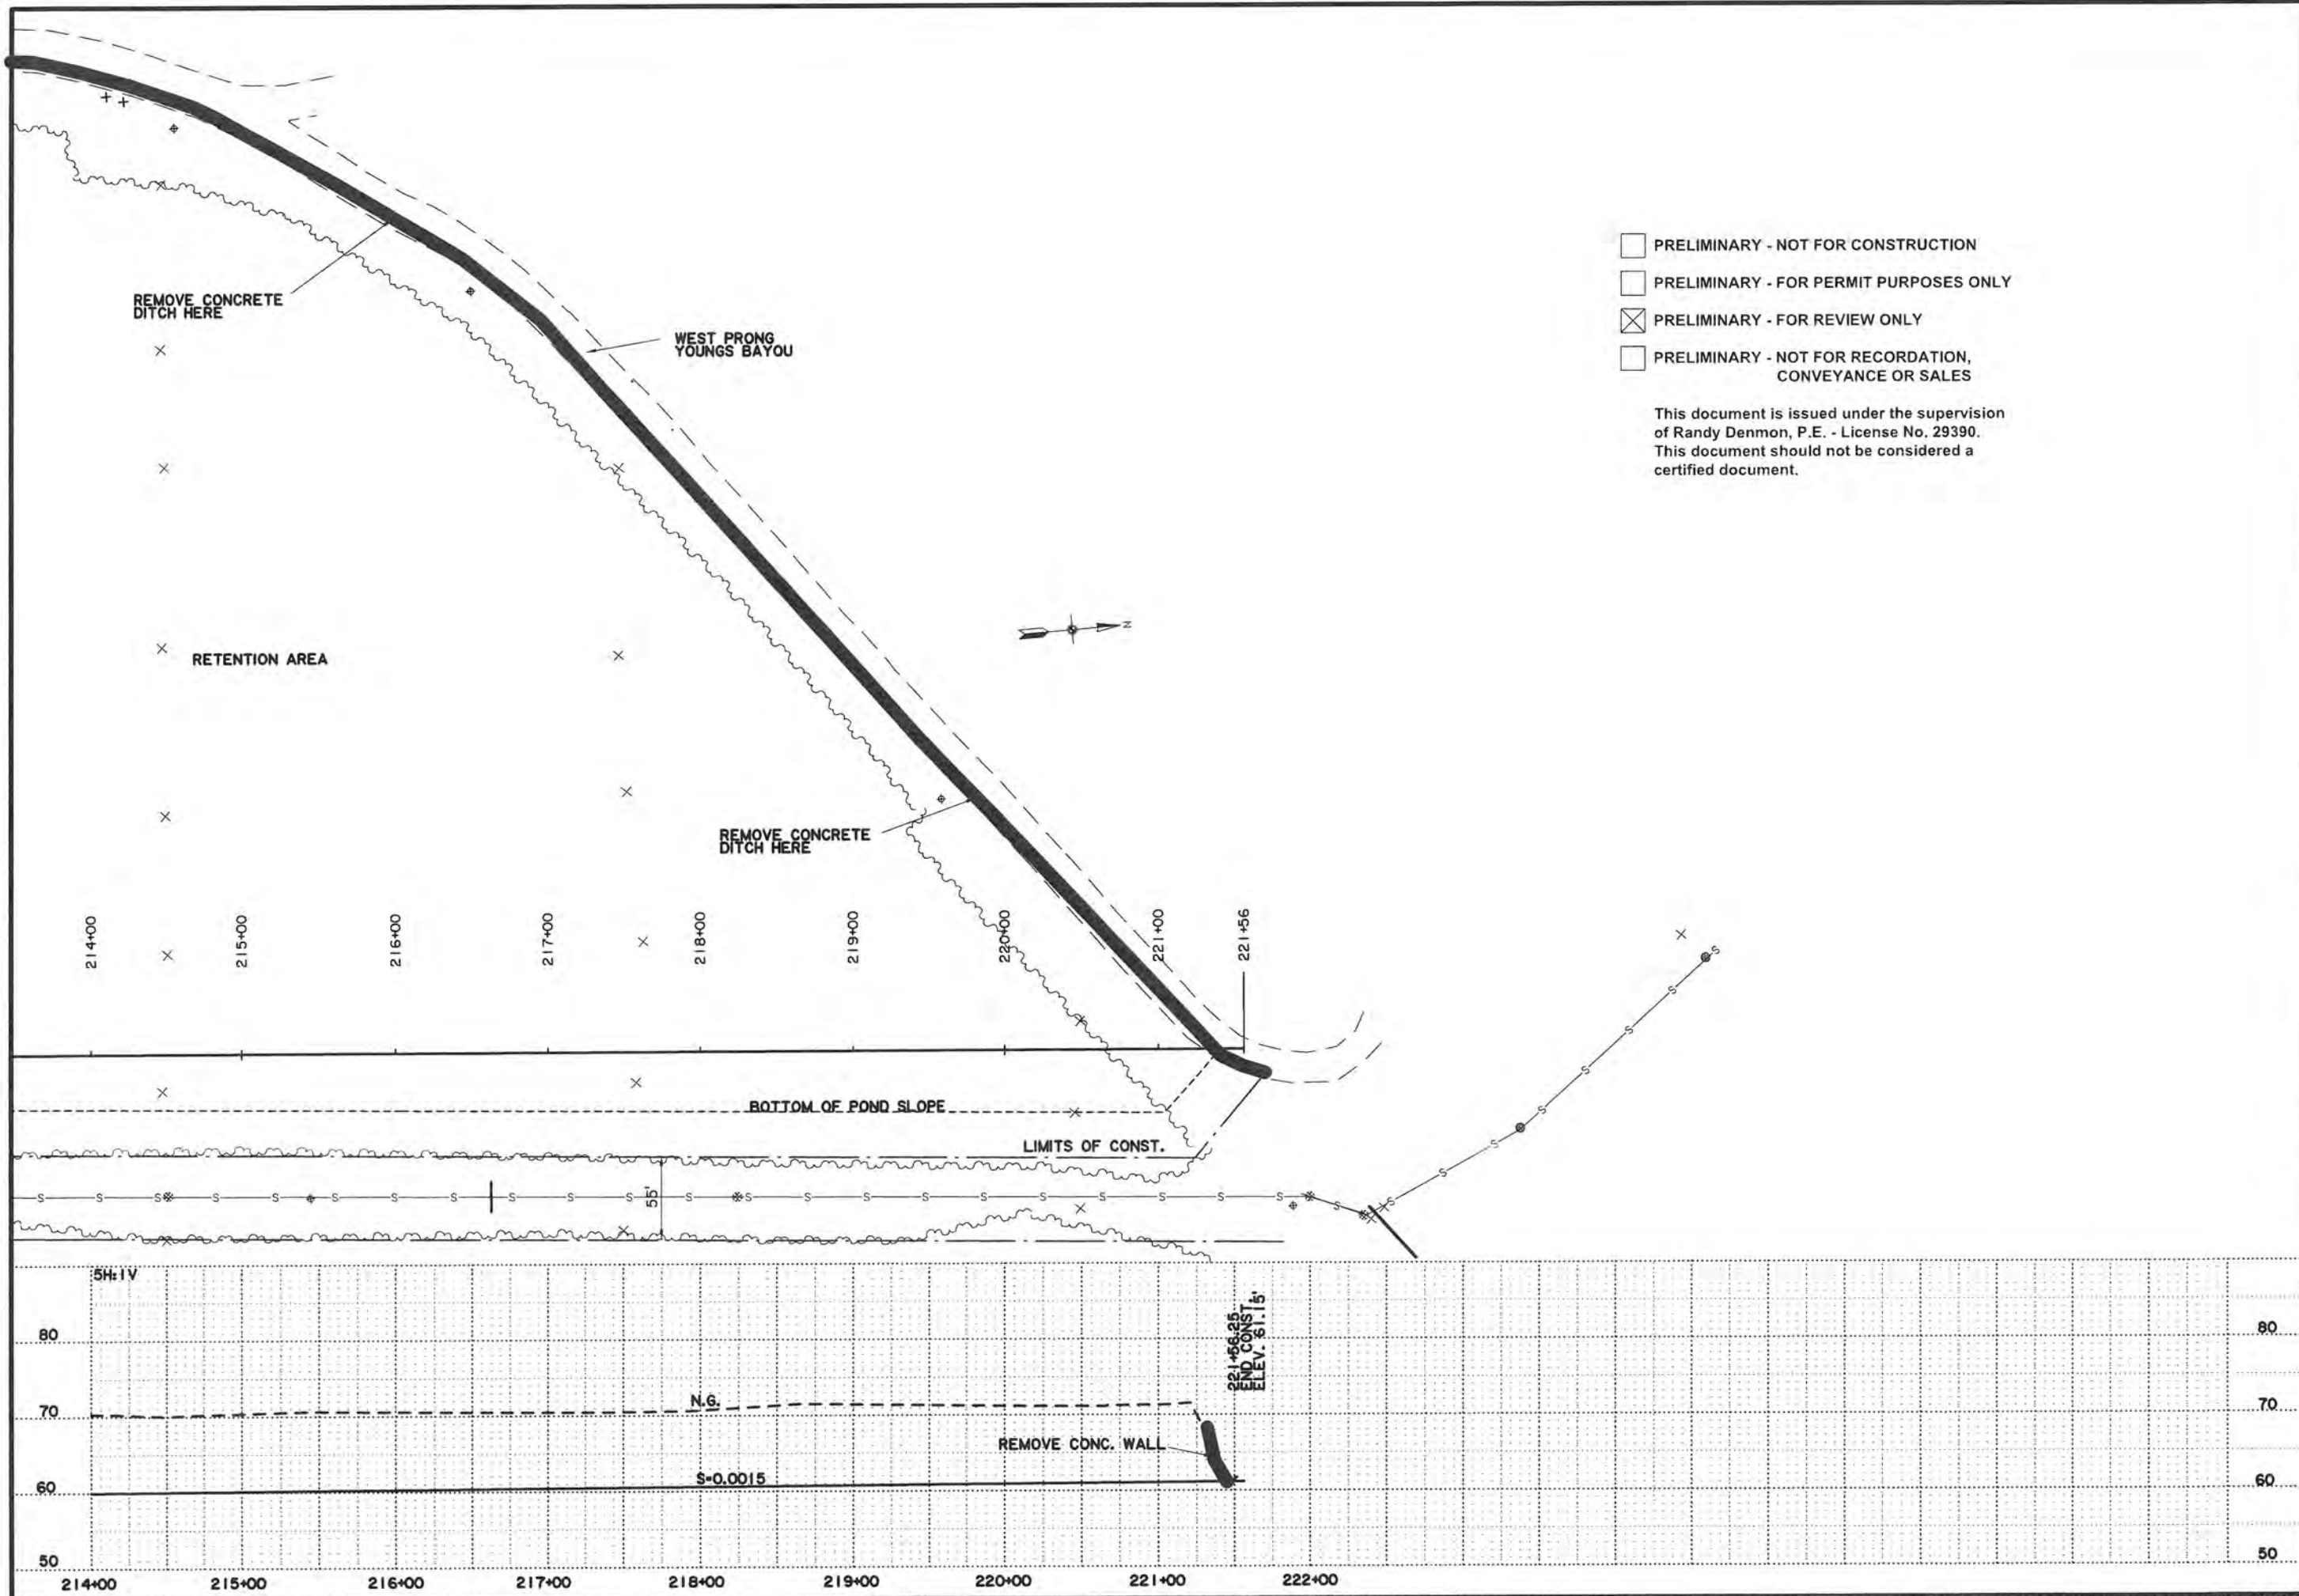
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SHEET NUMBER		8
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PLAN AND PROFILE SHEET		







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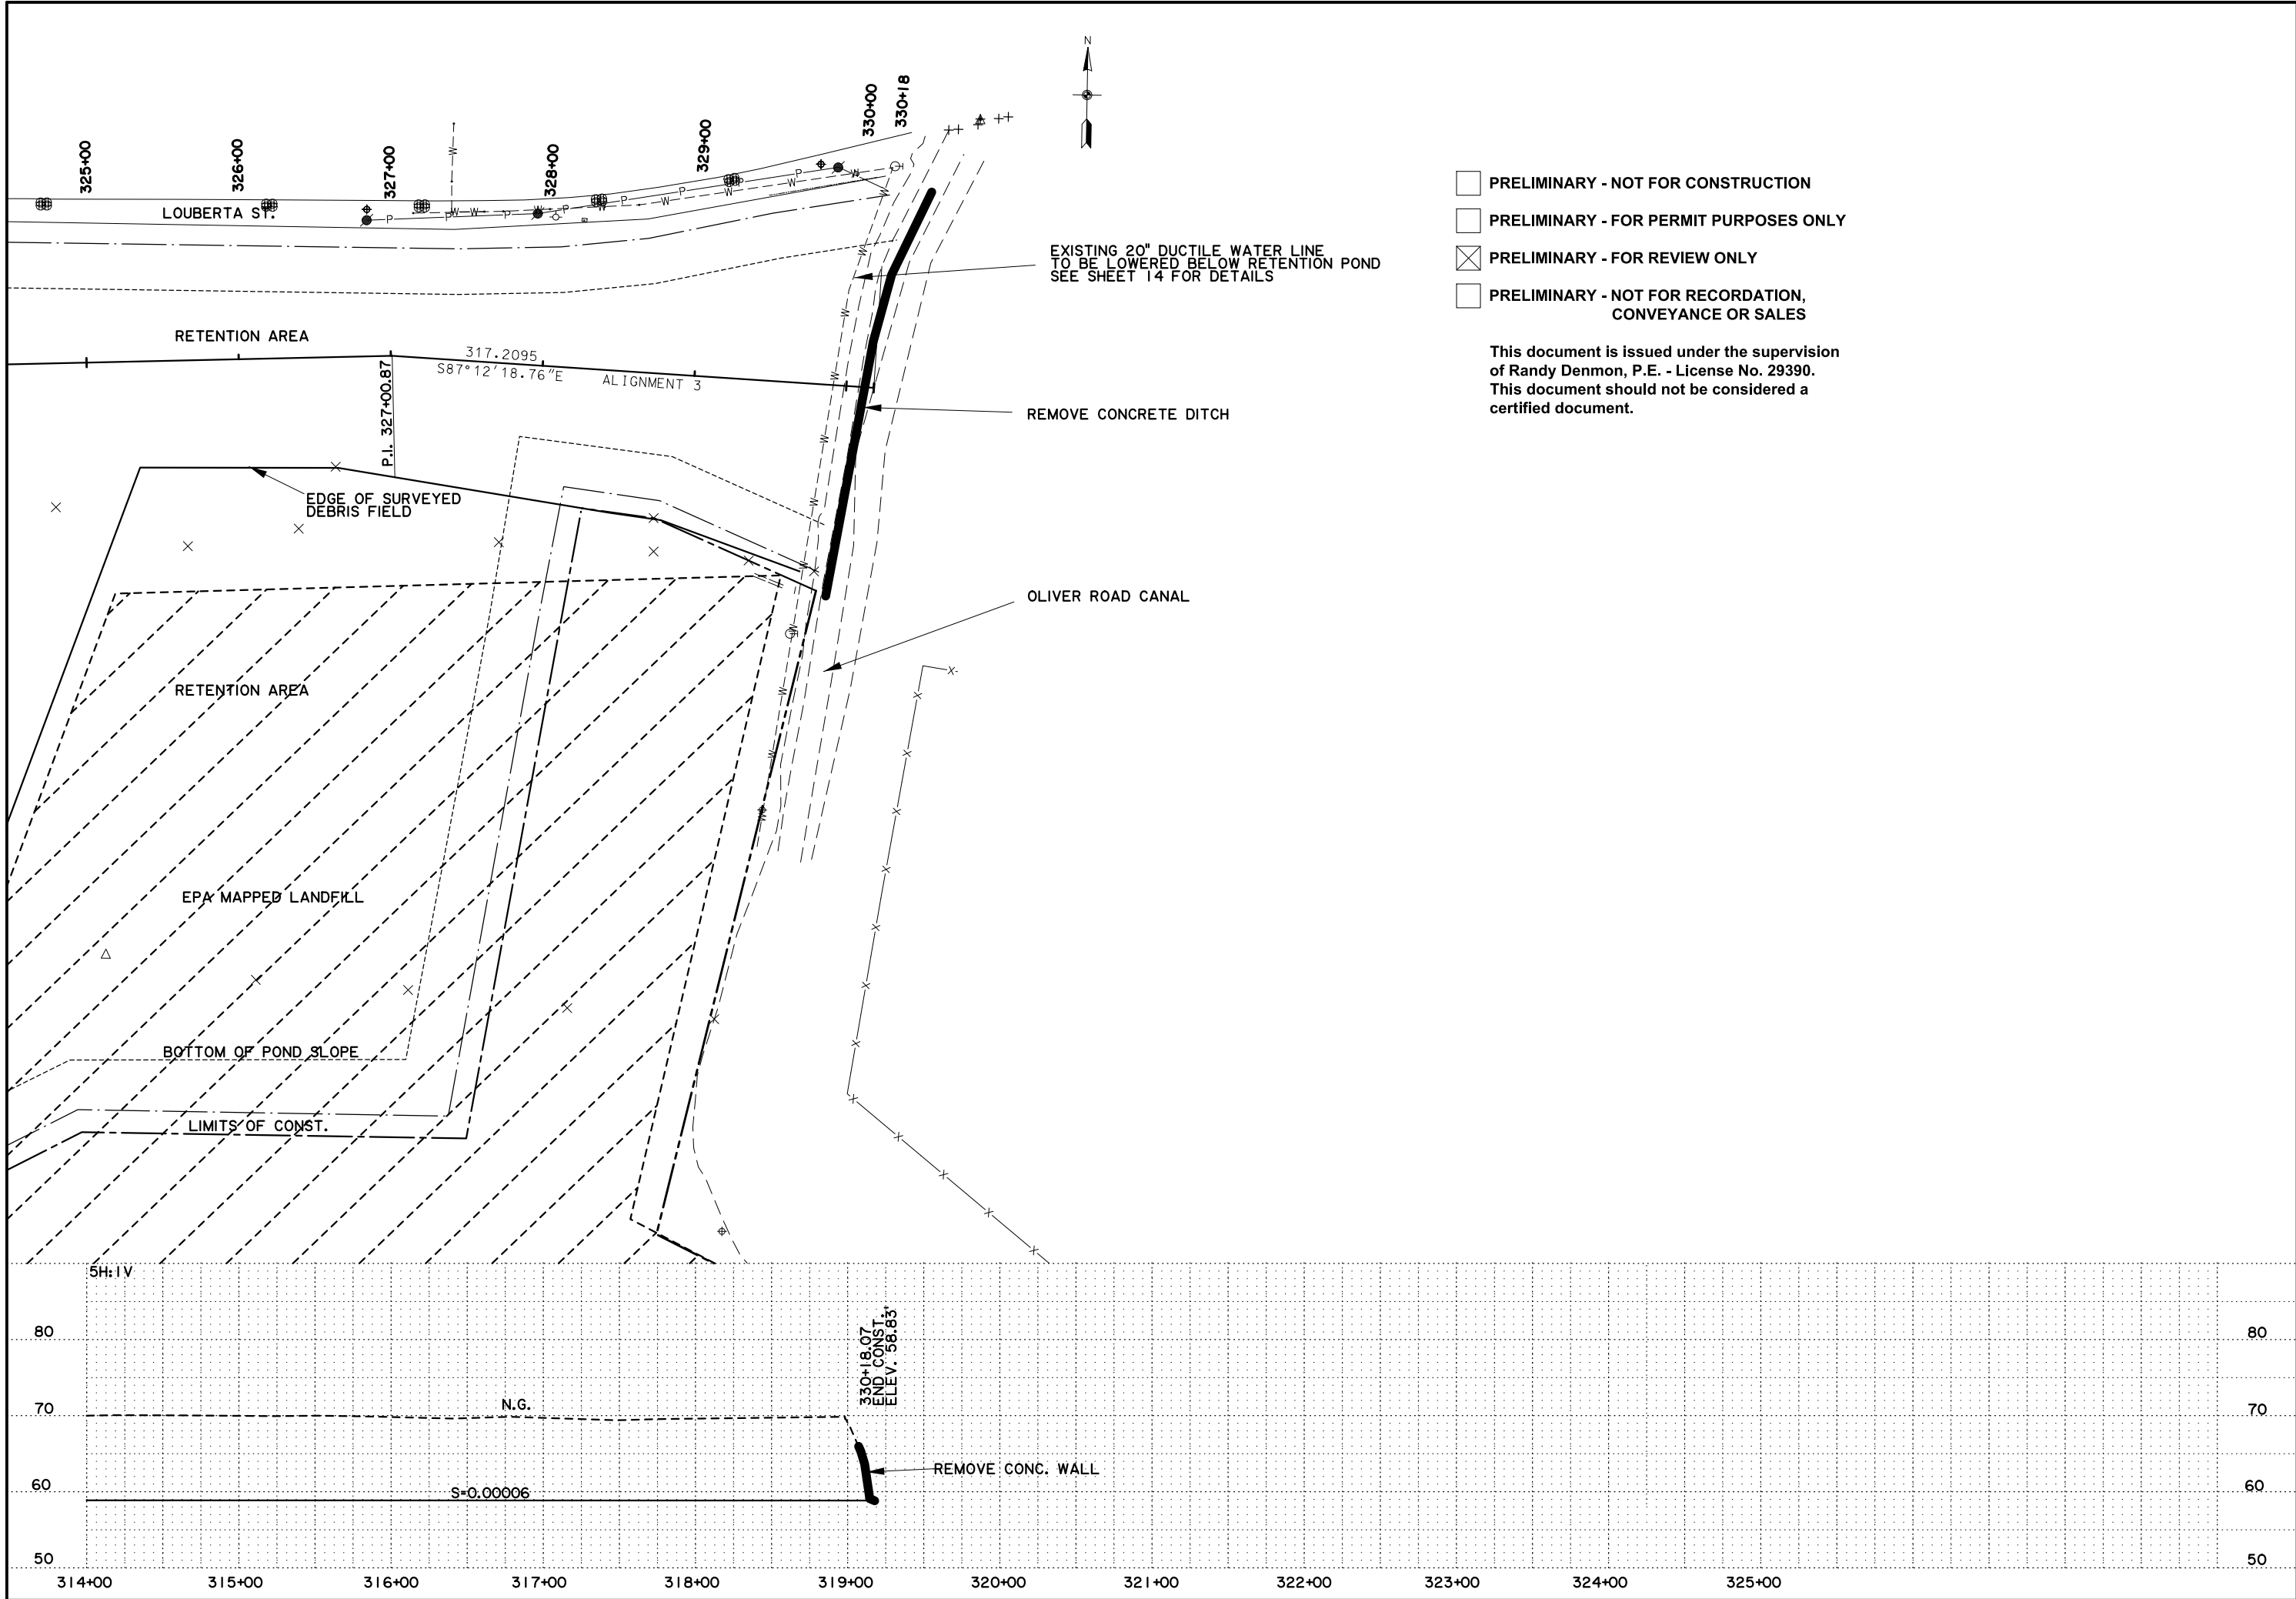
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YOUNGS BAYOU RETENTION			

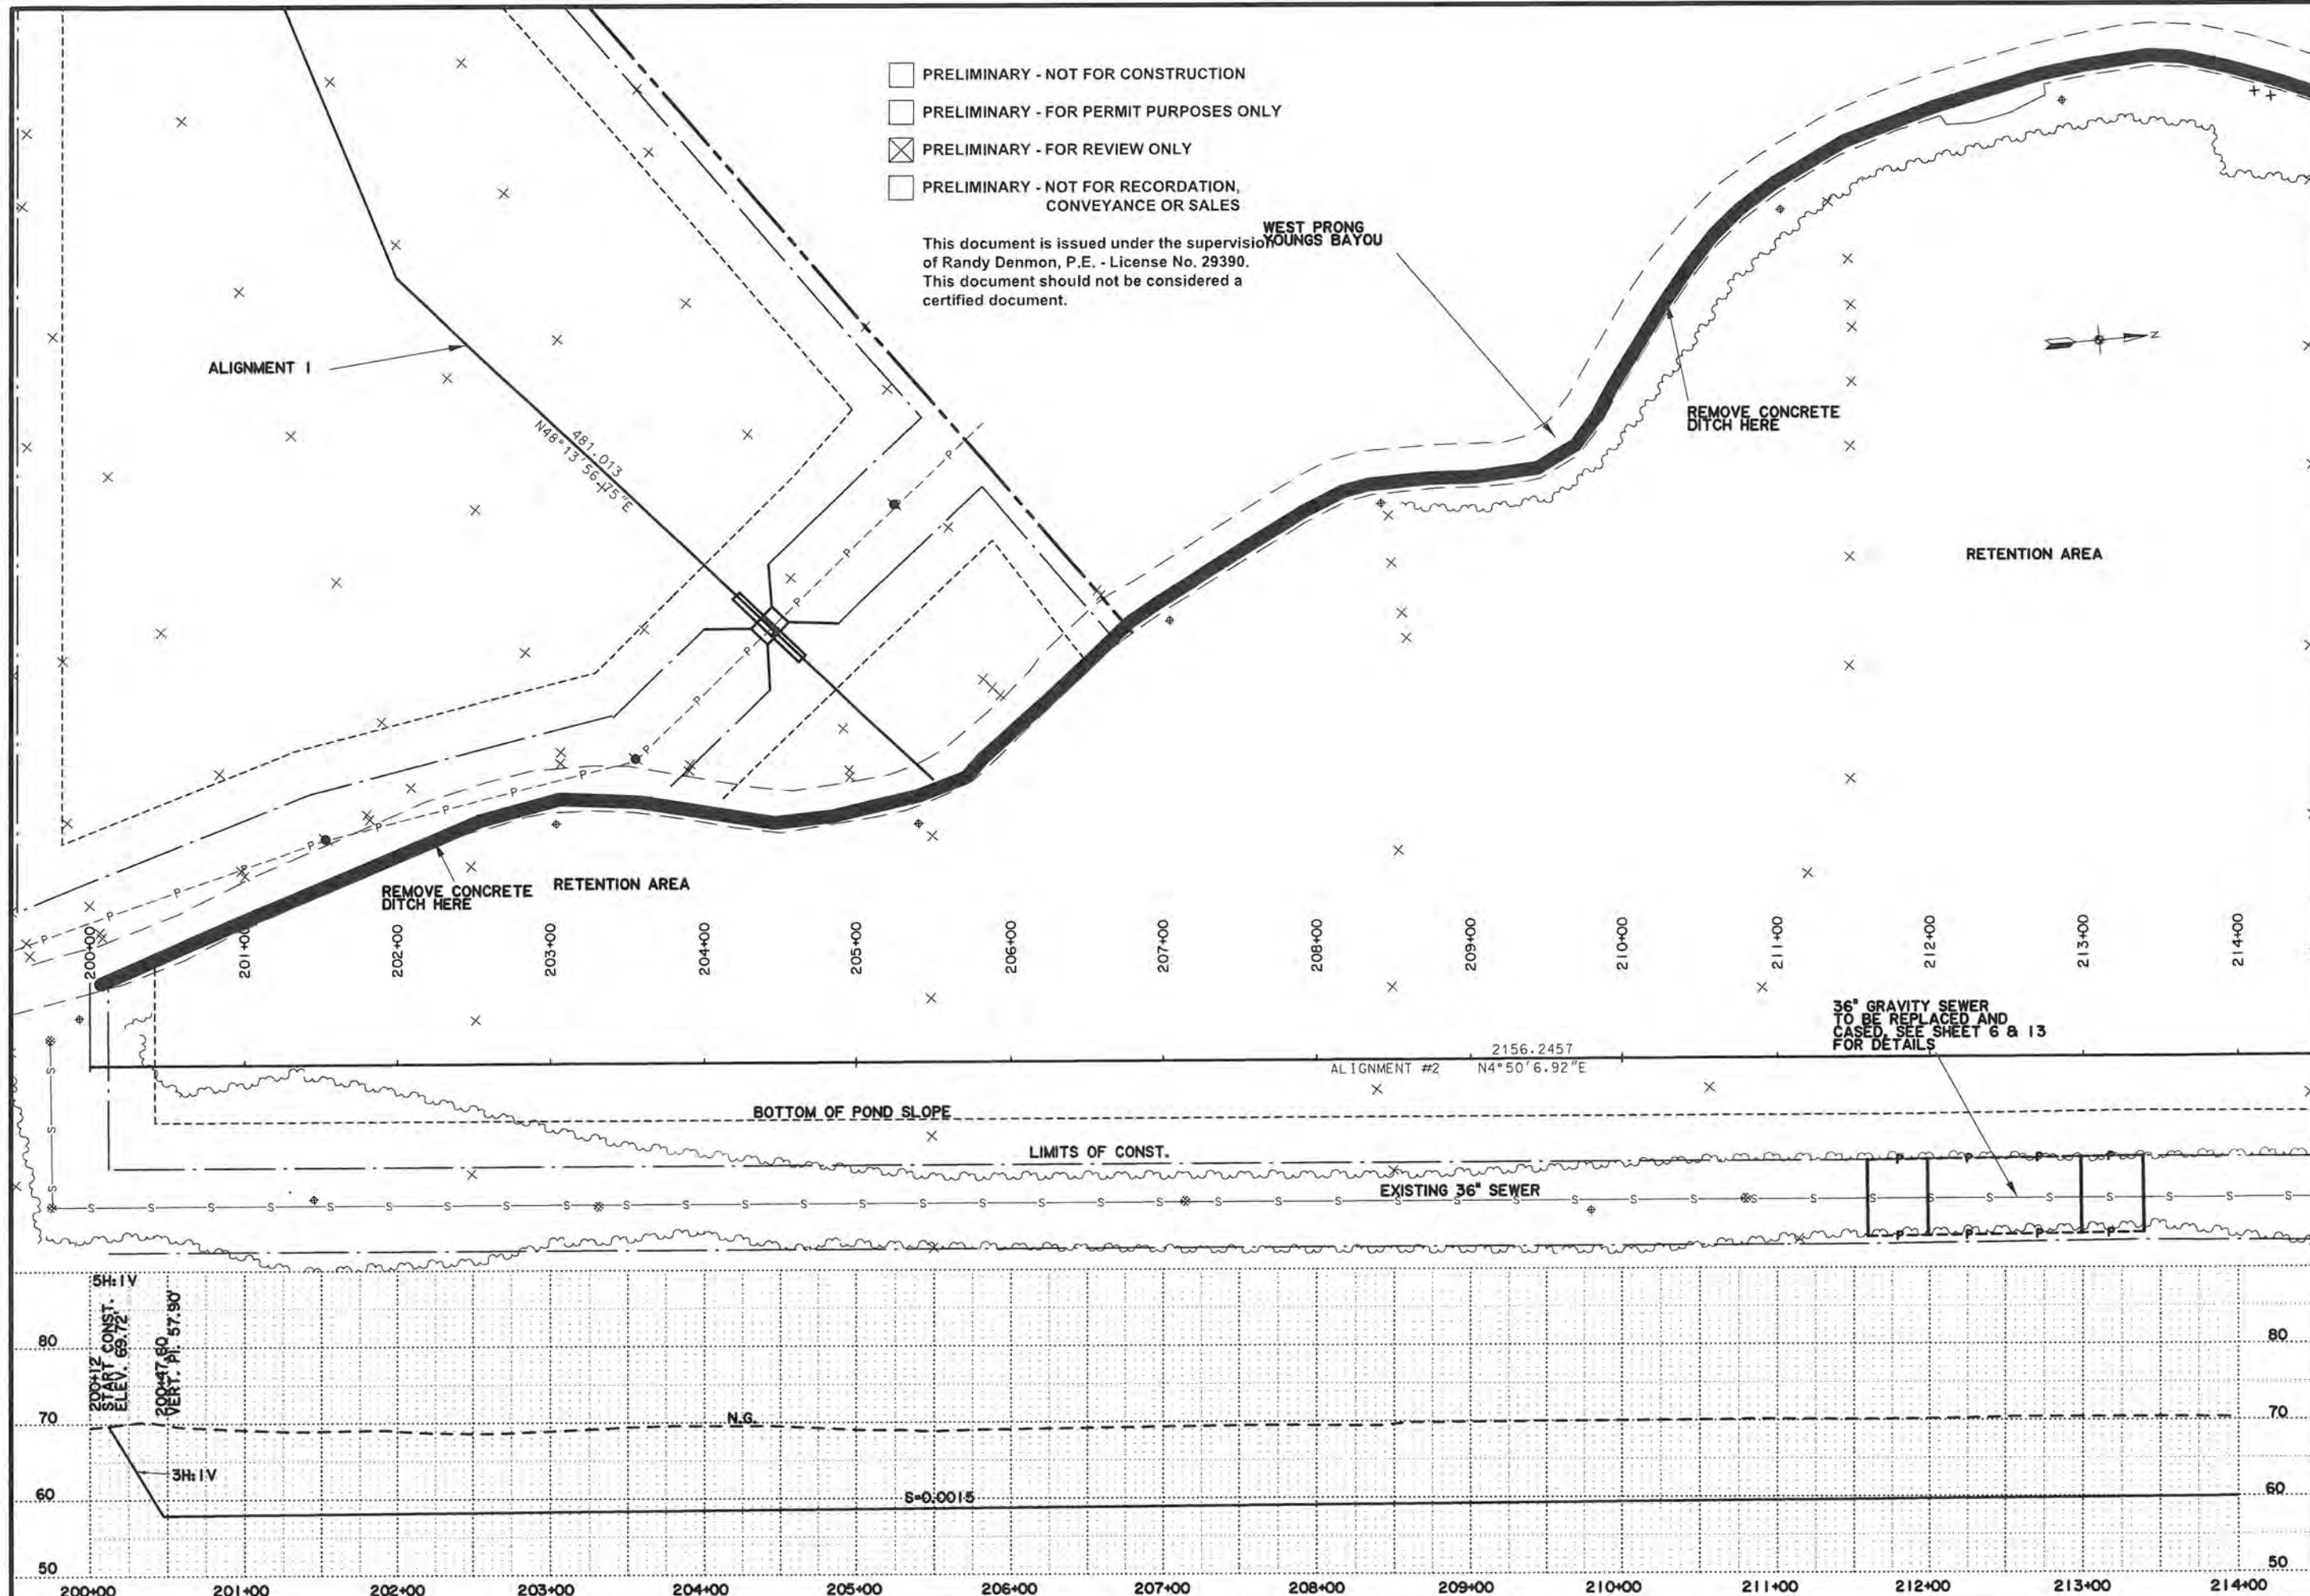

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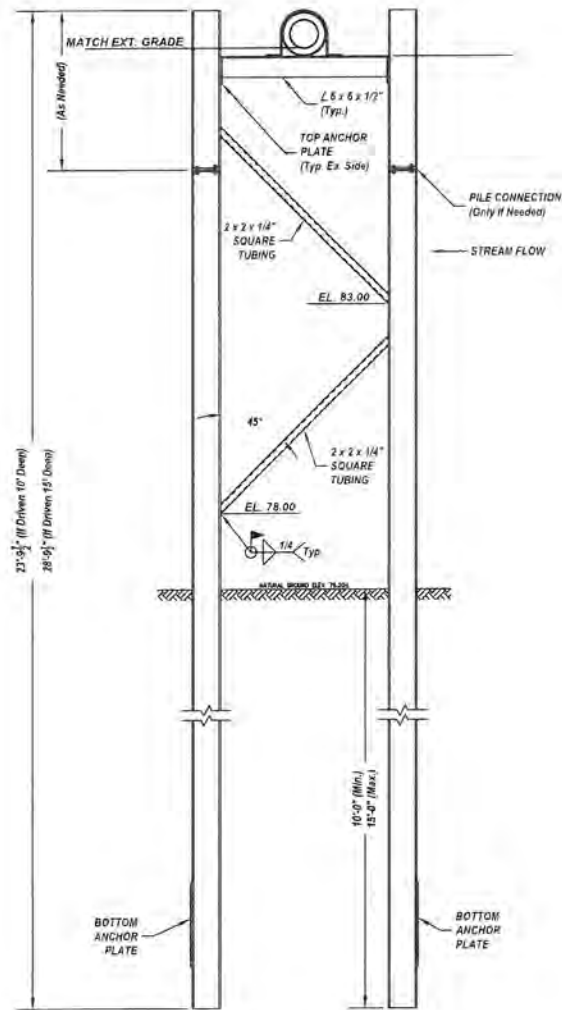

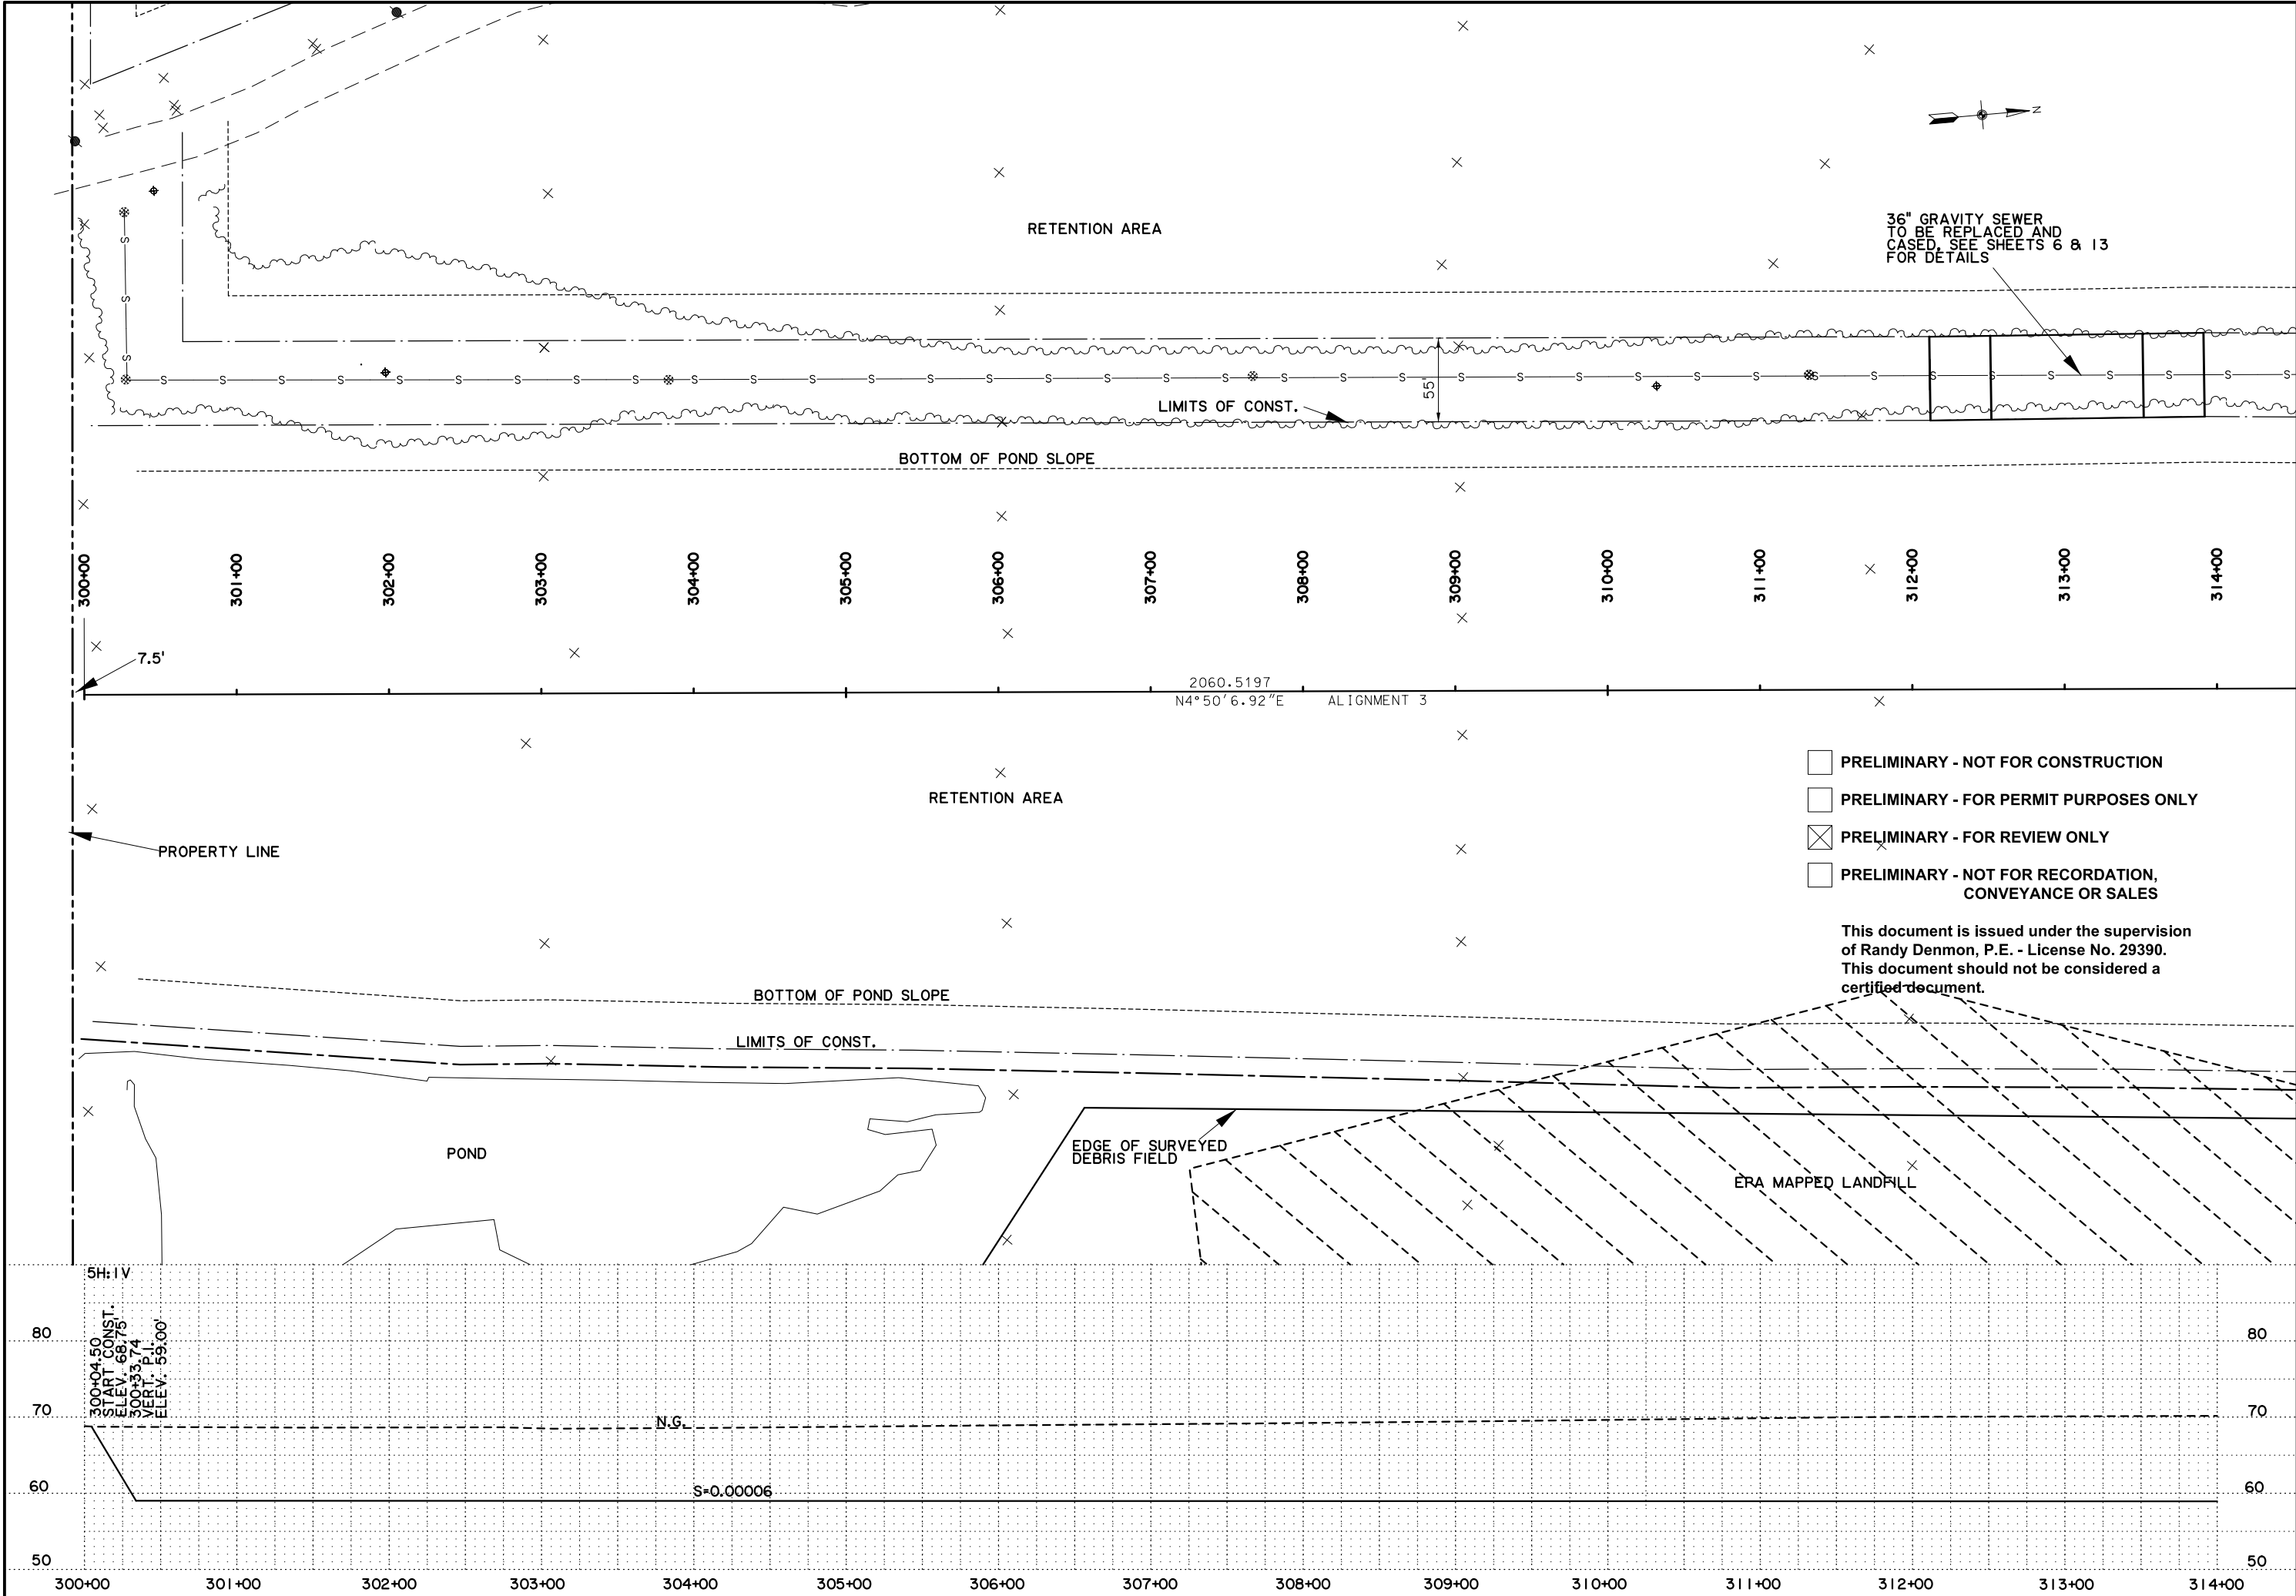
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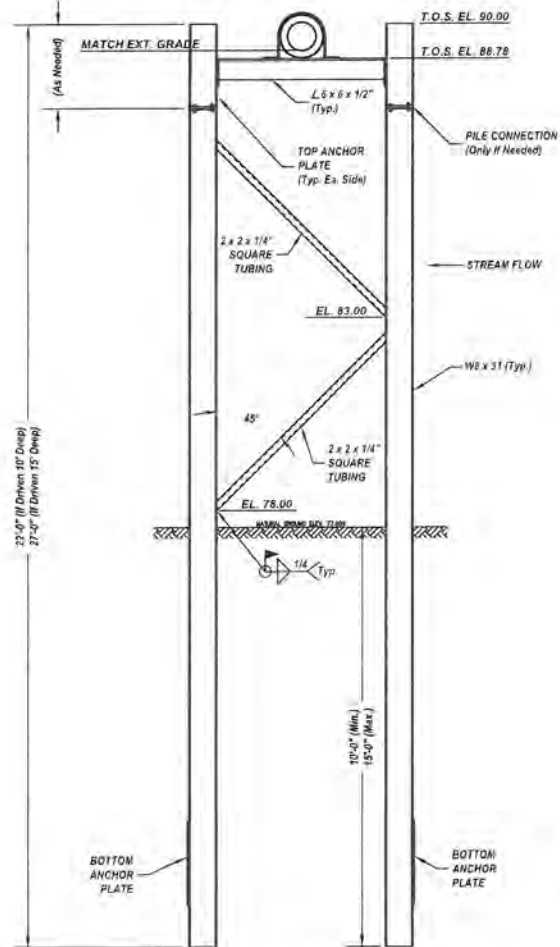
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PLAN AND PROFILE SHEET		YOUNGS BAYOU RETENTION	
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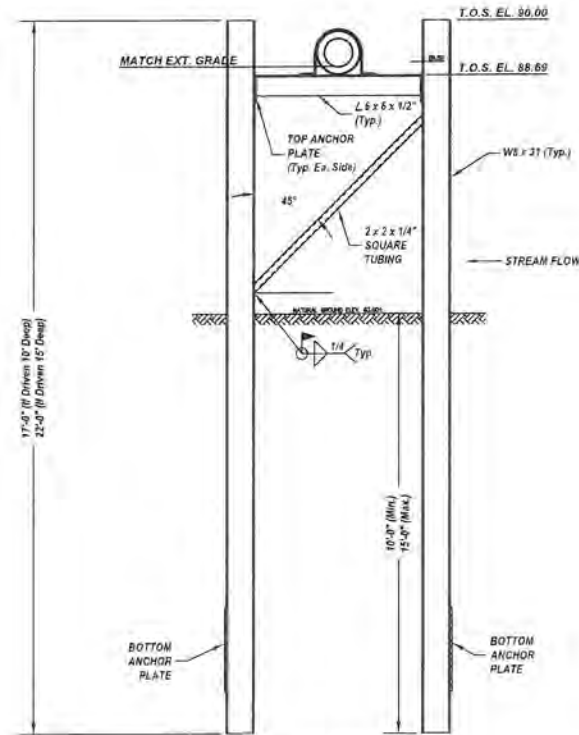


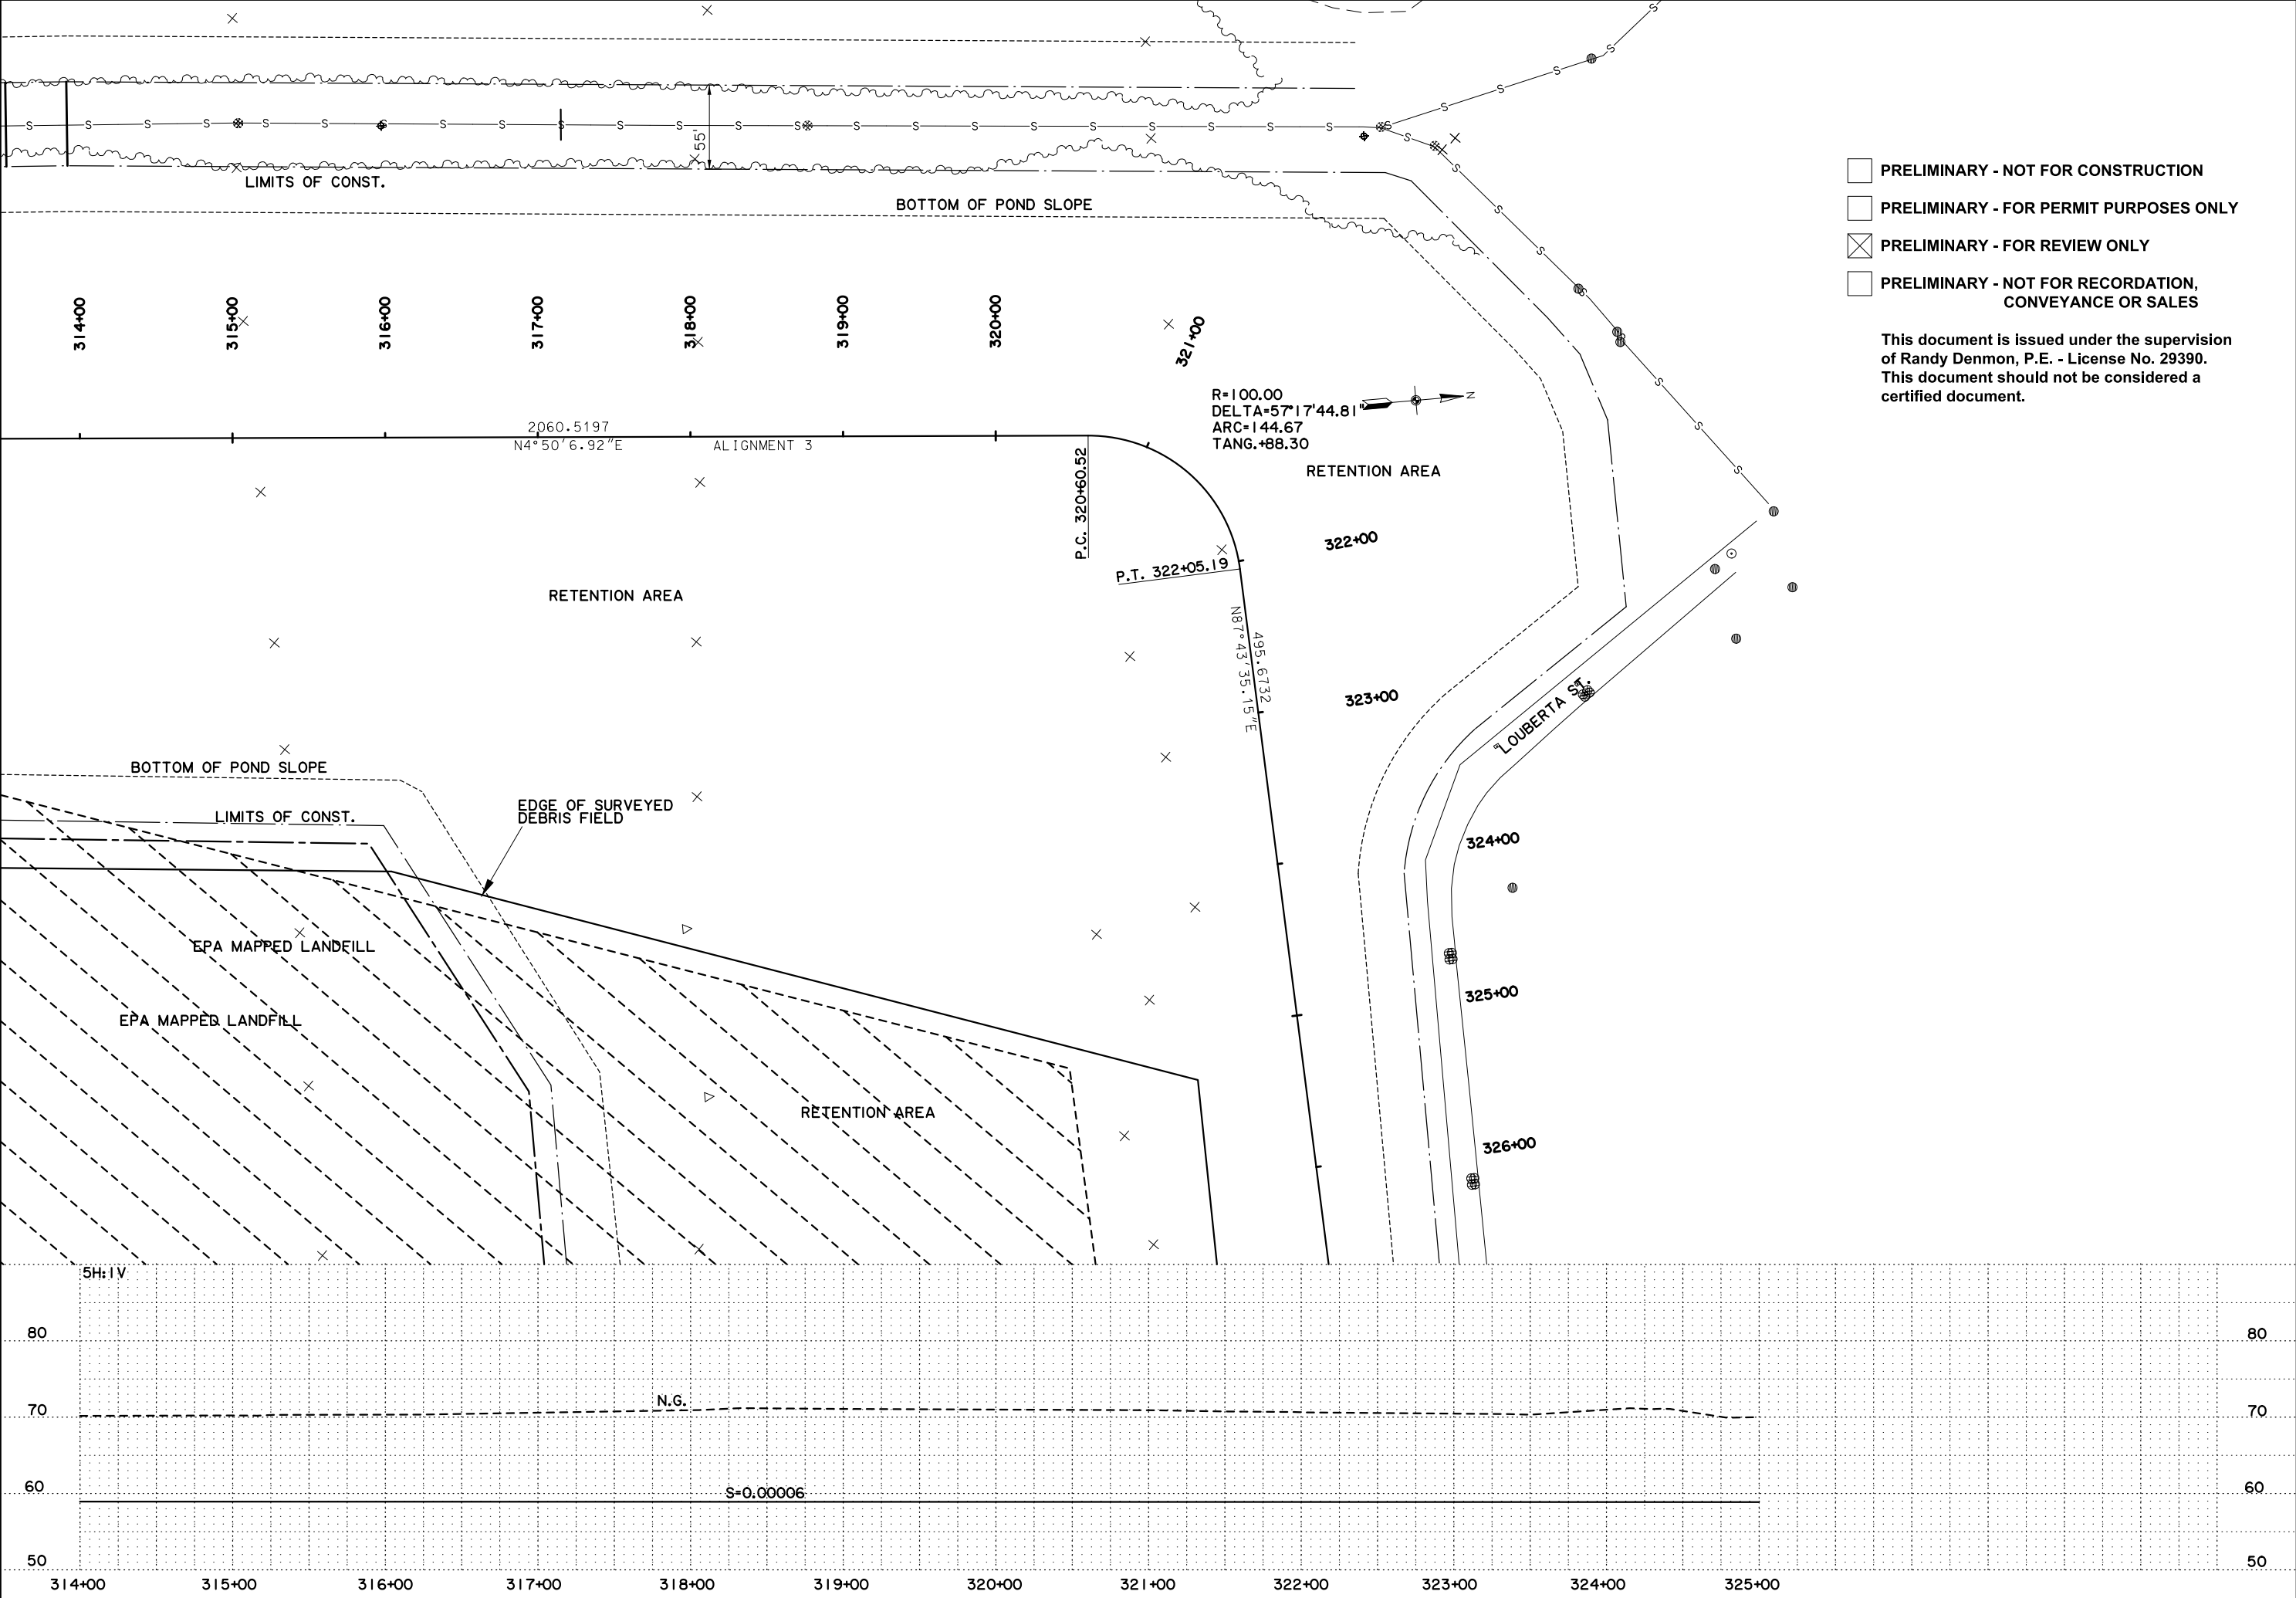


FRAME #1 ELEVATION



FRAME #2 ELEVATION




FRAME #3 ELEVATION

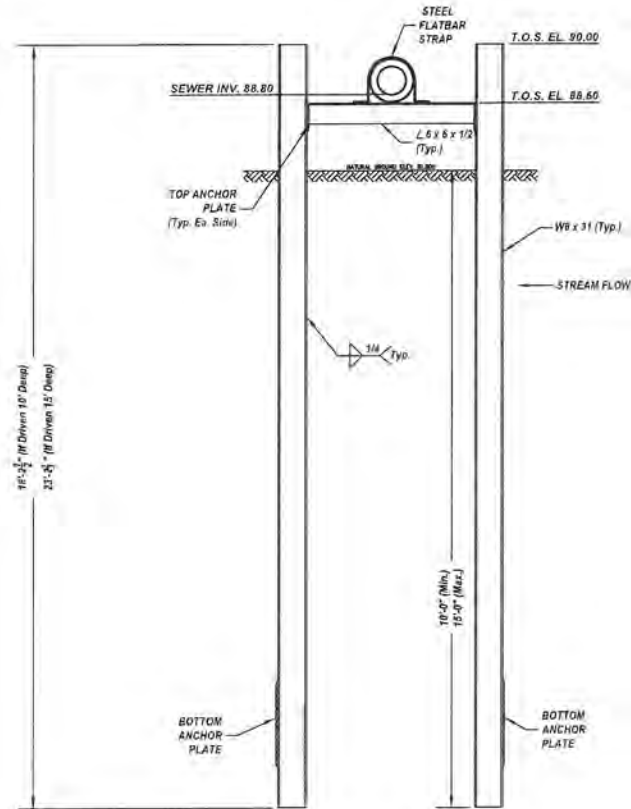


FRAME #4 ELEVATION

NOTES:


1. FOUR (4) NEW STEEL SUPPORT STRUCTURE FRAMES ARE REQUIRED FOR THIS PROJECT.
2. AT THE BEGINNING OF THE PILE DRIVING PROCEDURE, FULL LENGTH (25') W8x31's SHALL BE USED AT ALL LOCATIONS. SHOULD ANY OVERALL PILE LENGTH EXCEED 25', A BOLTED AND WELDED CONNECTION SHALL BE REQUIRED TO EXTEND EACH W8x31 PILE TO THE CORRECT FINISHED ELEVATION AS SHOWN.
3. EACH INDIVIDUAL W8x31 SHALL BE DRIVEN TO A MINIMUM DEPTH OF TEN (10) FEET, TO A MAXIMUM DEPTH OF FIFTEEN (15) FEET, OR TO THE POINT OF REFUSAL.
4. AFTER DRIVING EACH W8x31 PILE, EXCESS LENGTH ABOVE ELEVATION 90.00 SHALL BE CUT OFF AND REMOVED.
5. AFTER ALL BOLTED CONNECTIONS ARE MADE, ALL ELEVATIONS SHALL BE VERIFIED PRIOR TO FINAL WELDING-IN-PLACE.

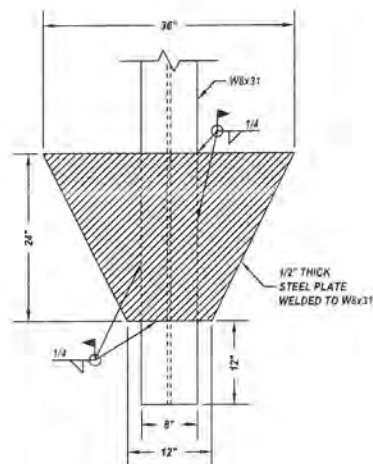


BOTTOM ANCHOR PLATE DETAILS

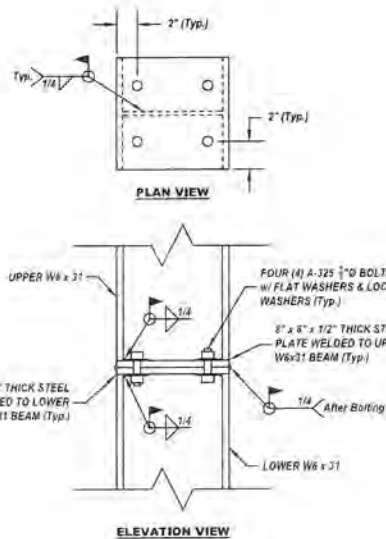


PILE CONNECTION DETAILS

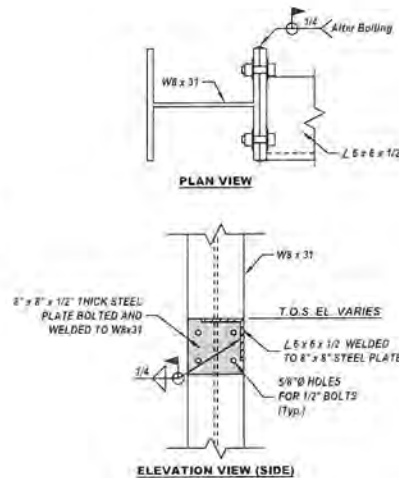


TOP ANCHOR PLATE DETAILS

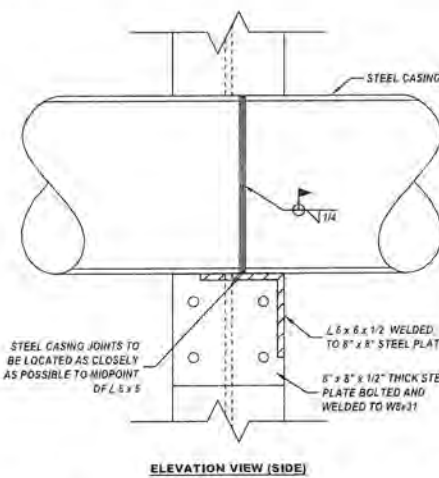

ENLARGED DETAIL AT CASING SPLICE

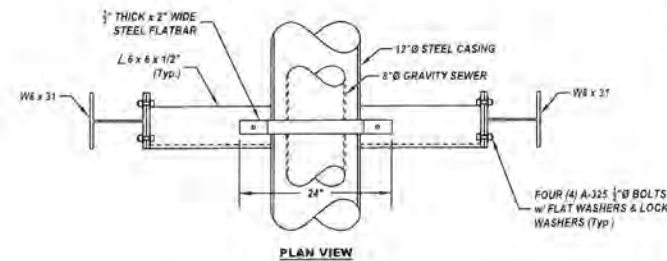

PLAN VIEW

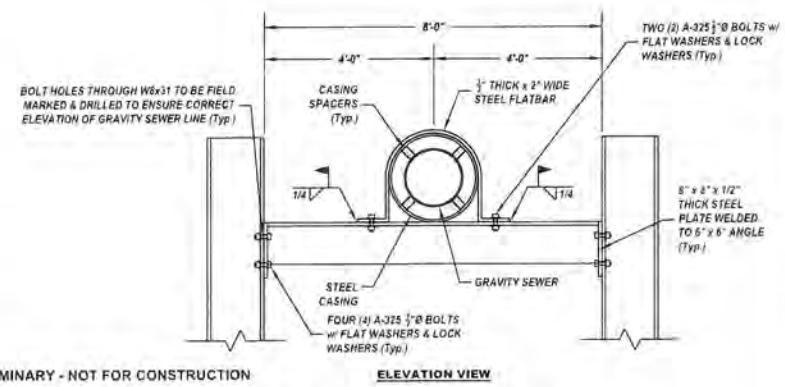

ENLARGED DETAIL AT TOP

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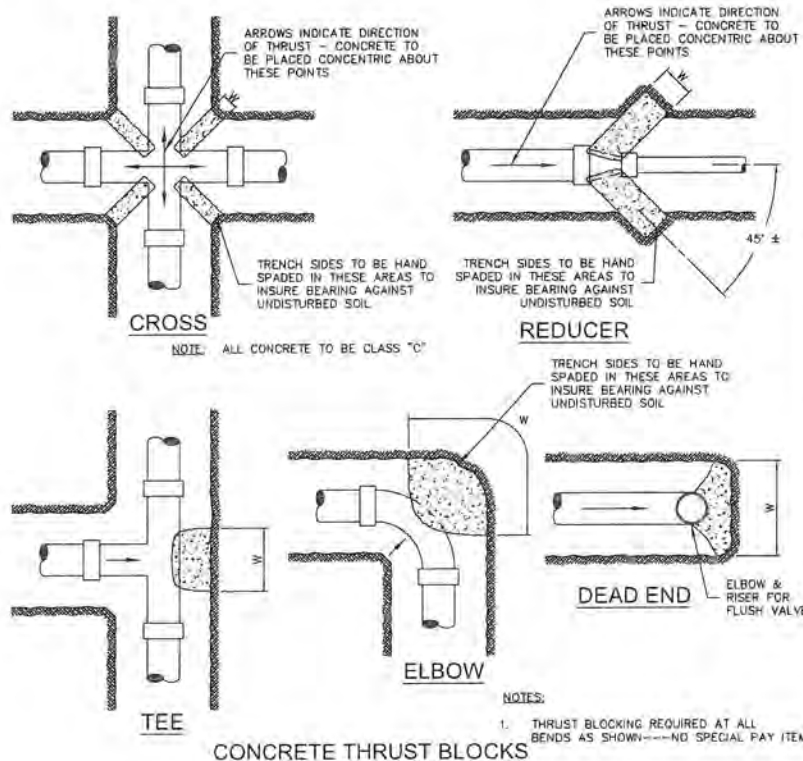
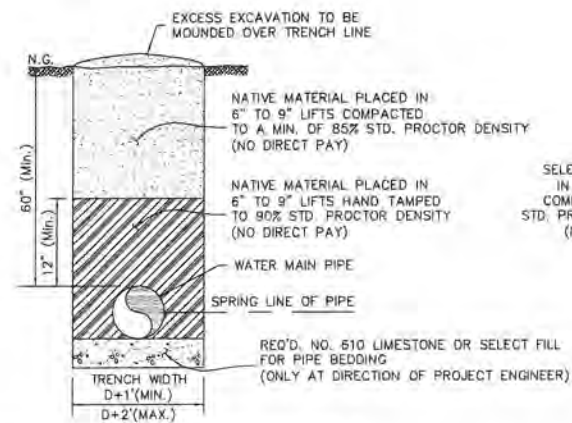
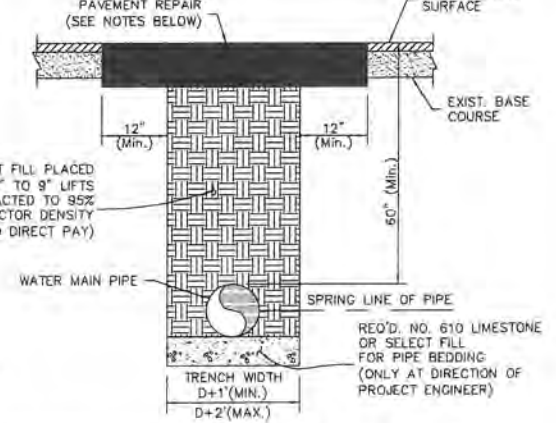


TABLE OF MINIMUM REQUIRED THRUST BLOCKING													
PIPE SIZE	DEAD END OR TEE		90° ELBOW		CROSS		45° ELBOW		22½° ELBOW		REDUCER SIZE	REDUCER	
	W	D*	W	D*	W	D*	W	D*	W	D*		W	D*
1 - ½"	12	12	12	12	12	12	12	12	12	12	3 - 2 ½	12	6
2"	12	12	12	12	12	12	12	12	12	12	3 - 2	12	6
2 - ½"	12	12	18	12	12	12	12	12	12	12	4 - 3	12	8
3"	18	12	24	12	18	12	18	12	12	12	5 - 4	12	10
3 - ½"	24	12	24	18	18	12	18	12	12	12	6 - 4	12	12
4"	18	18	24	24	18	18	18	12	12	12	6 - 5	12	12
5"	30	18	30	24	18	18	24	18	18	12	8 - 6	18	12
6"	30	24	36	30	24	18	24	24	24	12	10 - 8	24	18
8"	48	24	48	36	24	24	36	24	30	18	12 - 8	30	24
10"	48	36	60	48	36	24	42	36	30	24	12 - 10	30	24
12"	60	48	60	60	36	30	48	42	36	30			
16"	60	60	72	72	36	36	48	48	36	36			
20"	78	78	78	78	42	42	72	72	48	48			

\* DIMENSION "D" IS ⊥ TO "W" AND TO PLANE OF PAPER




WATER MAIN INSTALLATION DETAILS (NON TRAFFIC AREAS)




WATER MAIN INSTALLATION DETAILS (TRAFFIC AREAS)


- NOTES:
- IF EXISTING DRIVING SURFACE IS ASPHALT, USE 6" THICK ASPHALTIC CONCRETE, TYPE 1 (4" - 1st. LIFT, 2" - 2nd. LIFT).
  - IF EXISTING DRIVING SURFACE IS CONCRETE, USE 8" THICK (3,400 PSI) PORTLAND CEMENT CONCRETE w/6"x6", 6 GA. W.W. FABRIC - CONCRETE & REINFORCING SHALL MEET APPLICABLE PROVISIONS OF SECTION 601 L.O.H. SPECIFICATIONS.

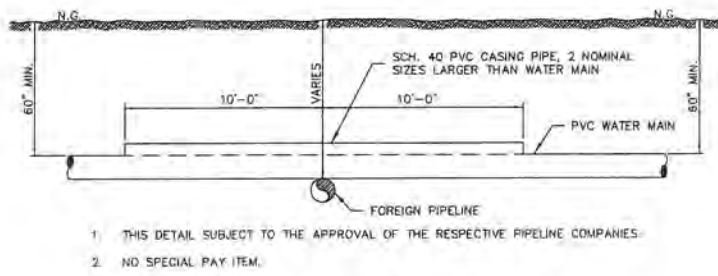


FOREIGN PIPELINE CROSSING DETAIL

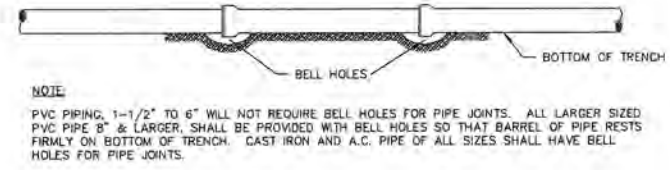

BELL HOLE DETAILS

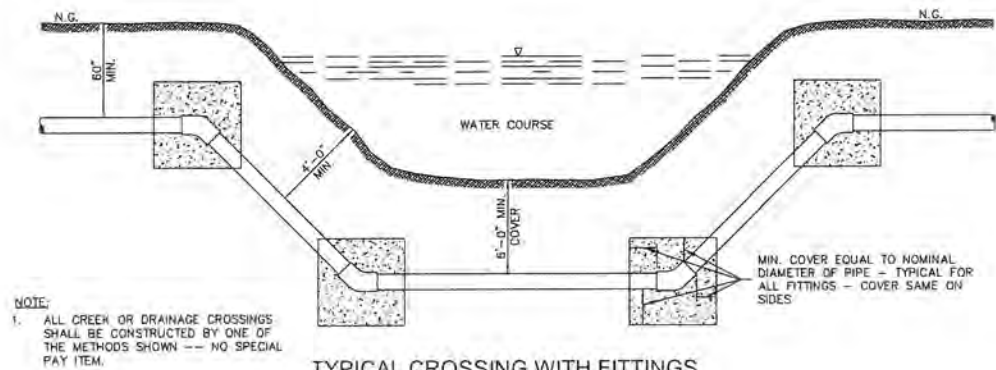

TYPICAL CROSSING WITH FITTINGS

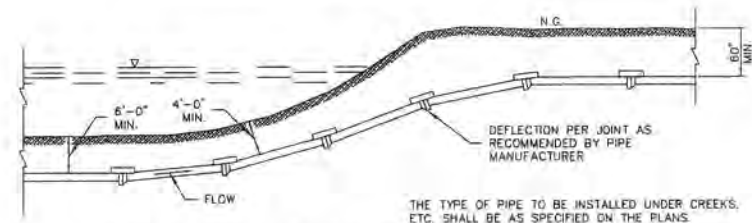

TYPICAL CROSSING USING JOINT DEFLECTION

DETAIL FOR CREEK OR DRAIN CROSSING

NOTE: AT CREEK AND DRAIN CROSSINGS, CONTRACTOR SHALL INSTALL AN APPROVED TYPE WEIGHT (PRECAST OR CAST IN PLACE) ON THE PIPE TO DEVELOP A NEGATIVE BUOYANCY. SIZE AND SPACING OF WEIGHTS SHALL BE AS DETERMINED FROM THE FOLLOWING SCHEDULE.

PIPE SIZE	PIPE ANCHORAGE
2"	4 LBS. PER L.F. PIPE
3"	7 LBS. PER L.F. PIPE
4"	12 LBS. PER L.F. PIPE
5"	18 LBS. PER L.F. PIPE
6"	25 LBS. PER L.F. PIPE
8"	43 LBS. PER L.F. PIPE
10"	XX LBS. PER L.F. PIPE
12"	XX LBS. PER L.F. PIPE
16"	XX LBS. PER L.F. PIPE
20"	XX LBS. PER L.F. PIPE

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